Drain: JR COLUNS #1	Drain #: <i>8</i> 8
Improvement/Arm: MERIDIAN CONNERS	PHASET HAMILTON CROSSING HEST PHASE IT
Operator: J. Livinias Tan	Date: 11-19-03
Drain Classification: Urban/Rural	Year Installed: 1989

GIS Drain Input Checklist

•	Pull Source Documents for Scanning	puf
•	Digitize & Attribute Tile Drains	J/A
•	Digitize & Attribute Storm Drains	- fent
•	Digitize & Attribute SSD	NA
•	Digitize & Attribute Open Ditch	furf
•	Stamp Plans	- Jang
•	Sum drain lengths & Validate	for f
•	Enter Improvements into Posse	- Jus
•	Enter Drain Age into Posse	
•	Sum drain length for Watershed in Posse	
•	Check Database entries for errors	- Jus

Gasb 34 Footages for Historical Cost Drain Length Log

Drain-Improvement: J.R. COLUMS - HAMILTON CROSSING WEST PHASE IT

Drain Type:	Size:	Length (Length (DB Query)	Length Reconcile	Price:	Cost:
RCP	15"	550	559'	9'	111001	Oost.
	18"	43'	43'	0		
	21"	48	150'	102		
	24"	716'	521'	-195'		······································
	27"	370'	357'	-13'		·
	30"	56'	50'	0		
	36"	290'	290'	0		
·	42"	1416'	1416'	0		
	484	757	757'	0		
	54"	267'	267'	0		
OPEN DITCH		660'	480'	-180		
rcp	21"	55'	55'	0		

ouni,	SLUC	4143	- 277	-	
	•				

	Final	Report:_	52351
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Comments:

E REGULATED DRAIN FINAL REPORT
· · · · · · · · · · · · · · · · · · ·
79205-90000
:

* ZI" RCP (55') APPEARS ON ASBULTS FOR MERIDIAN CORNER BLVD
RELOCIATION (1999) AS EXISTING. EVEN THOUGHT IT DOES NOT APPEAR
ON THE AGBUILTS OR IN THE REPORTS FOR THESE IMPRIVEMENTS,
IT IS ADDED HERE BECAUSE IT ENSTS AND IS REGULATED.

This copy printed from the Digital Archive of the Hamilton County Surveyor's Office; One Hamilton Co. Square, Ste. 188, Noblesville, In 46060





Kenton C. Ward, Surveyor

Phone (317) 776-8495

Fax (317) 776=9628

Suite 146 One Hamilton County Square Noblesville, Indiana 46060=2230

July 28, 1995

To: Hamilton County Drainage Board

Re: J.R. Collins #1

Hamilton Crossing West II & Meridian Corners Phase I

Attached are as-builts, certificate of completion & compliance, and other information for Hamilton Crossing West & Meridian Corners. An inspection of the drainage facilities for this section has been made and the facilities were found to be complete and acceptable.

During construction, changes were made to the drain which will alter the plans submitted with my report for this drain dated 9/12/88. The changes are as follows: The two 30" RCP pipes at the south end of the detention pond were replaced with Structures 743 to 742 which consists of 35' of 36" RCP and Structure 742 to 741 which consists of 255' of 36" RCP. Structure 735 to 710 that consisted of 252' of 18" RCP was not constructed. Structure 735 to Structure 706 of Phase I was left off the report. This structure was altered by 10' during Phase II. It now consists of 26' of 27" RCP. Structure 703 to the detention pond was changed from 217' of 54" RCP to 267' of 54" RCP.

The length of the drain due to the changes described above is now 5235 feet.

Non-enforcements will be presented on a site by site basis.

The bond or letter of credit from United States Fidelity & Guaranty Co., number 31-0120-1054-89-2, dated 5/30/89, in the amount of \$90,000.00, has been released.

I recommend the Board approve the drains construction as complete and acceptable.

Kenton C. Ward,

Hamilton County Surveyor

KCW/jlk



Kenton C. Ward, Surveyor

776=9626

Noblesville, Ind. 46060 September 12, 1988 verbal report given at meeting

TO: Hamilton County Drainage Board

RE: J.R. Collins #1 Drain REVISED REPORT

Attached is a petition, drain map drainage shed map assessment roll and my original report to the Board, dated August 5, 1988, plans, calculations for the J.R. Collins #1 Drain. At this time the drain is number 30 on the Reconstruction List.

Attached is the submittals and petition and I have found each to be in proper form. The petition requests the drain to be relocated as shown on the attached plan from Cripe Engineers, dated September 1, 1988 and file stamped September 1, 1988, and described below. The petitioner will submit the non-enforcement requests at a later date.

I have made a personal inspection of the land described in the petition. Upon doing so, I believe that the drain is practicable; will improve the public health; benefit a public highway and be of public utility; and that the costs, damages and expenses of the proposed drain will probably be less than the benefits accuring to the owners of land likely to be benefitted. The petitioner shall bear all cost for the relocation.

The original drain will be intercepted at approximately STA 15 as described in the 1890 report. The relocated drain will then run West along the South side of 131st Street as storm sewer to the West side of the proposed Meridian Corners Blvd. The relocated drain will then be piped to run South along the West side of Meridian Corners Blvd. to an outlet into a retention facility. The drain will exit the South end of the retention facility via two (2) 30" RCP's and into a new open ditch. The relocated regulated drain will end at the South property line of James M. & Dorothy Correll, which is tract 09-35-00-00-001. The original drain

between STA 15 and 49+35 of the original 1890 report will be vacated. STA 49+35 is approximately the North line of the Correll property. STA 49+35 to the terminus at STA 53+05 will be left as described in the 1890 report.

The actual regulated drain will end at the original location which is thirty-six (36) feet South of the above described property line on the property of Lauth, Robert L. & Robin S., Tract 09-35-01-01-003, Lot 8 Williams Creek Farms. This tract is being notified although it is not being assessed at this time because maintenance work may be done on the drain in this short section sometime in the future. Sometime in the future the Board may also want to consider adding the remaining section of open ditch to the regulated drain, thus extending it approximately 1300 feet to Williams Creek through Williams Creek Farms.

The proposed regulated drain will also include other protions of the drainage plan for Meridian Corners. These shall include three (3) laterals running East under Meridian Corners Blvd. North of Dorset Blvd, storm sewer running West of the Main Drain along Dorset Blvd. to Springmill Road and the storm sewer system running along 126th Street. The retention facility will not be part of the regulated drain nor will the storm sewer line under 126th Street near the U.S. #31 R/W which empties into the retention facility for the Eaton & Lauth Meridian Park Place project. The system is within the W.R. Fertig Drainage Shed. The maintenance of the retention facility shall be the responsibility of the Developer.

The portions included in the regulated drain will be those pipes between structures 740,739,727,726,725,734,724,732,733,731,730,723,729,722,737,736, 728,735,703,704, STA 0+00, 703, pipe and inlets under Dorset Blvd. built with Phase 1, from STR 710 and 735 and 126th Street from STR 736 and 737. The pipe stubs running out of STR 731,733,729,722,723 and 724 are not included in the regulated drain at this time but may be in the future as the project developes.

The new lengths are as follows:

15" RCP	550ft	Open Ditch 660ft	30"	RCP	100ft
18" RCP	409ft	(Pond outlet to South	42"	RCP	1416ft
21" RCP	48ft	line Correll property)	48"	RCP	757ft
24" RCP	716ft	27" RCP 344ft	54"	RCP	217ft

I recommend the drain also be placed on a maintenance program at this time. I believe maintenance should be set at \$5.00 per acre, \$25.00 minimum. With 245.52 acres in the drainage shed the total annual assessment shall be \$1297.70. The drain should also be classified as an Urban Drain.

A hearing has been set for October 11, 1988. If approved at the hearing I recommend that petitioner be given one (1) year from date of approval for completion and submit a Performance Bond or Letter of Credit or other surety for 100% of the estimate within fifteen (15) days of approval. Said surety to run for a two (2) year period. The Surety is to be released upon final inspection by the Surveyor and submittal of "As Built" drawing. If not submitted the approval should be vacated at the next Board meeting.

KCW/no

Kenton C. Ward

Hamilton County Surveyor





Kenton C. Ward, Surveyor

776=9626

Noblesville, Ind. 46060 August 5, 1988

TO: Hamilton County Drainage Board

RE: J.R. Collins #1 Drain

Attached is a petition, non-enforcement request, plans, calculations for the J.R. Collins #1 Drain.

Attached is the submittals and petition and have found each to be in proper The petition requests the drain to be relocated as shown on the attached plan and described below.

I have made a personal inspection of the land described in the petition. Upon doing so, I believe that the drain is practicable; will improve the public health; benefit a public highway and be of public utility; and that the costs, damages and expenses of the proposed drain will probably be less than the benefits accuring to the owners of land likely to be benefitted. The petitioner shall bear all cost for the relocation.

The relocation will begin at approximately STA 15 of the original drain as described in the 1890 report. The original drain will be vacated from STA 16 to approximately STA 41+90. The drain will then consist of 1170 feet to 15" RCP, 627 feet of 42" RCP., 765 feet of 48" RCP and 205 feet of 54" RCP.

I recommend a hearing be set for October 1988.

1988 AUG 8

KCW/no

HAMILTON GOODE JANANAGE BOAR

Hamilton County Surveyor


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EDEODWANCE BOND


J.R. COLLINS


<u> </u>	Approved by The American Institute o	f Architects
ेश्र	Approved by the American institute o	
	A. I. A. Document No. A-311 (February	
2		NUMBER 31 0120 10514 89 2
	KNOW ALL MEN BY THESE PRESENTS:	
	That Gradex, Inc., 3100 E. 56th Street, Indi	anapolis, Indiana 46220
4	4020-000-000-000-000-000-000-000-000-000	
	hereinafter called Contractor, and UNITED STATES FIDELITY AND GUARANTY COMPA	NNY, a corporation organized and existing under the law
1	of the State of Maryland, Baltimore, Maryland, as Surety, hereinafter called Surety,	are held and firmly bound unto
	Dukemill Associates Limited Partnership and Ham	ilton County Commissioners
	as Obligee, hereinafter called Owner, in the amount of Ninety thousand	and no cents
	for the payment whereof Contractor and Surety hind the market at the contractor.	
	severally, firmly by these presents.	utors, administrators, successors and assigns, jointly and
	WHEREAS. Contractor has by written agreement dated May 30,	1989 optored into a contract vitt o
	Rejudation of Legal Drain construction of the	lake and nonformance as are in
	aramage improvements for indultion crossing we	st Phase II
	in accordance with drawings and enecifications according Paul Crine In	oc 7172 Graham Boad
	in accordance with drawings and specifications prepared by Paul Cripe, Indianapolis, Indiana, 46250	re insert full name, title and address)
	Indianapolis, Indiana 46250 hereof, and is hereinafter referred to as the Contract.	, which contract is by reference made a part
}	nereol, and is nereinatter referred to as the Contract	
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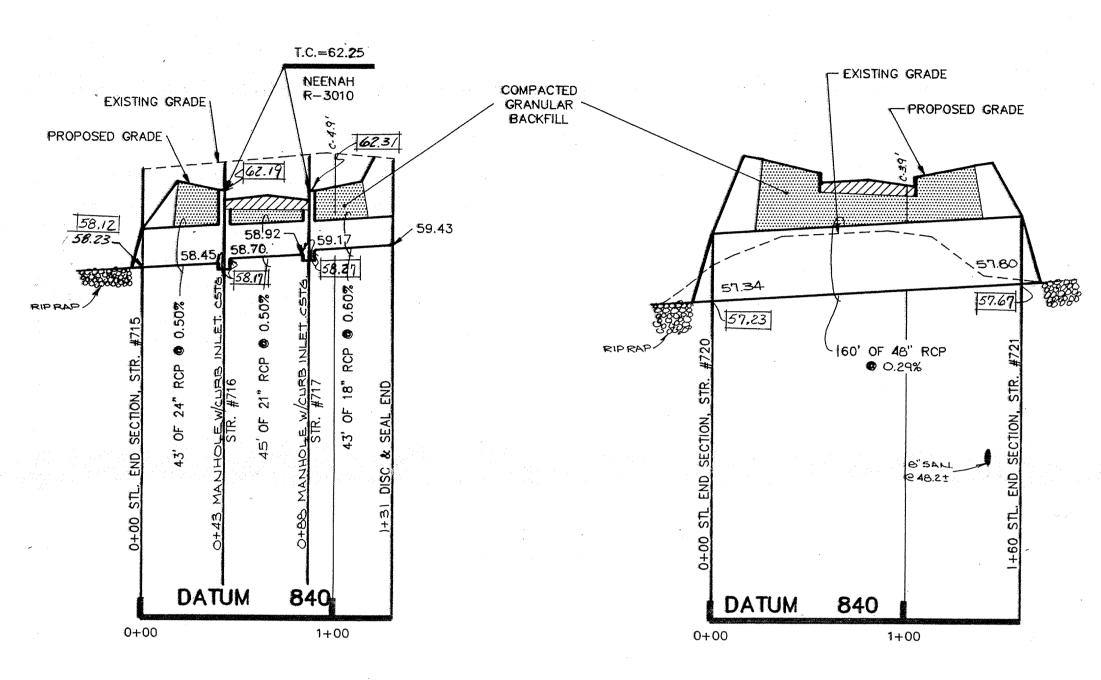
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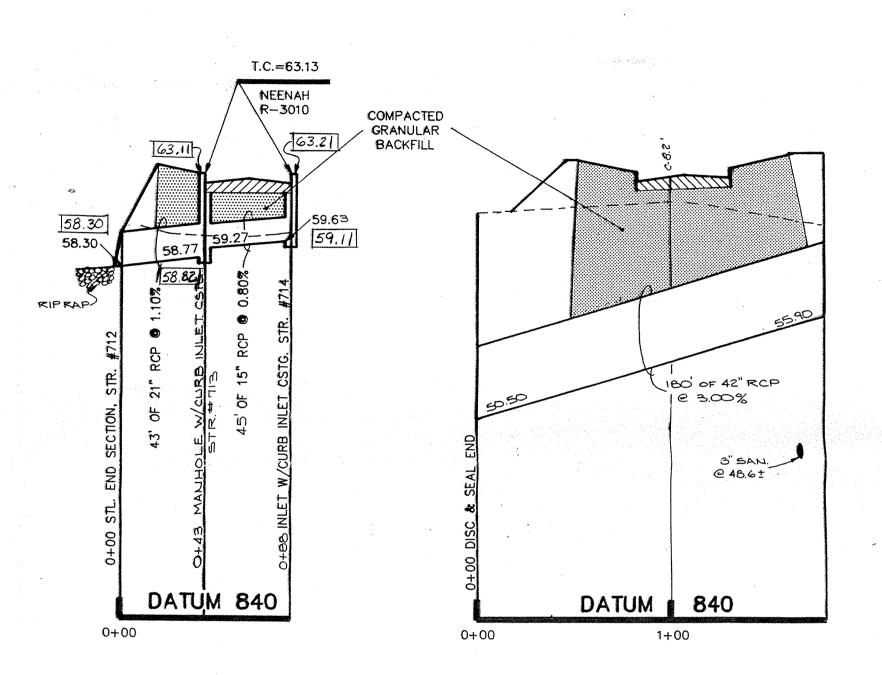


NOTE: CUTS SHOWN ARE APPROXIMATE, TAKEN FROM EXISTING GRADE TO INVERT OF PIPE.



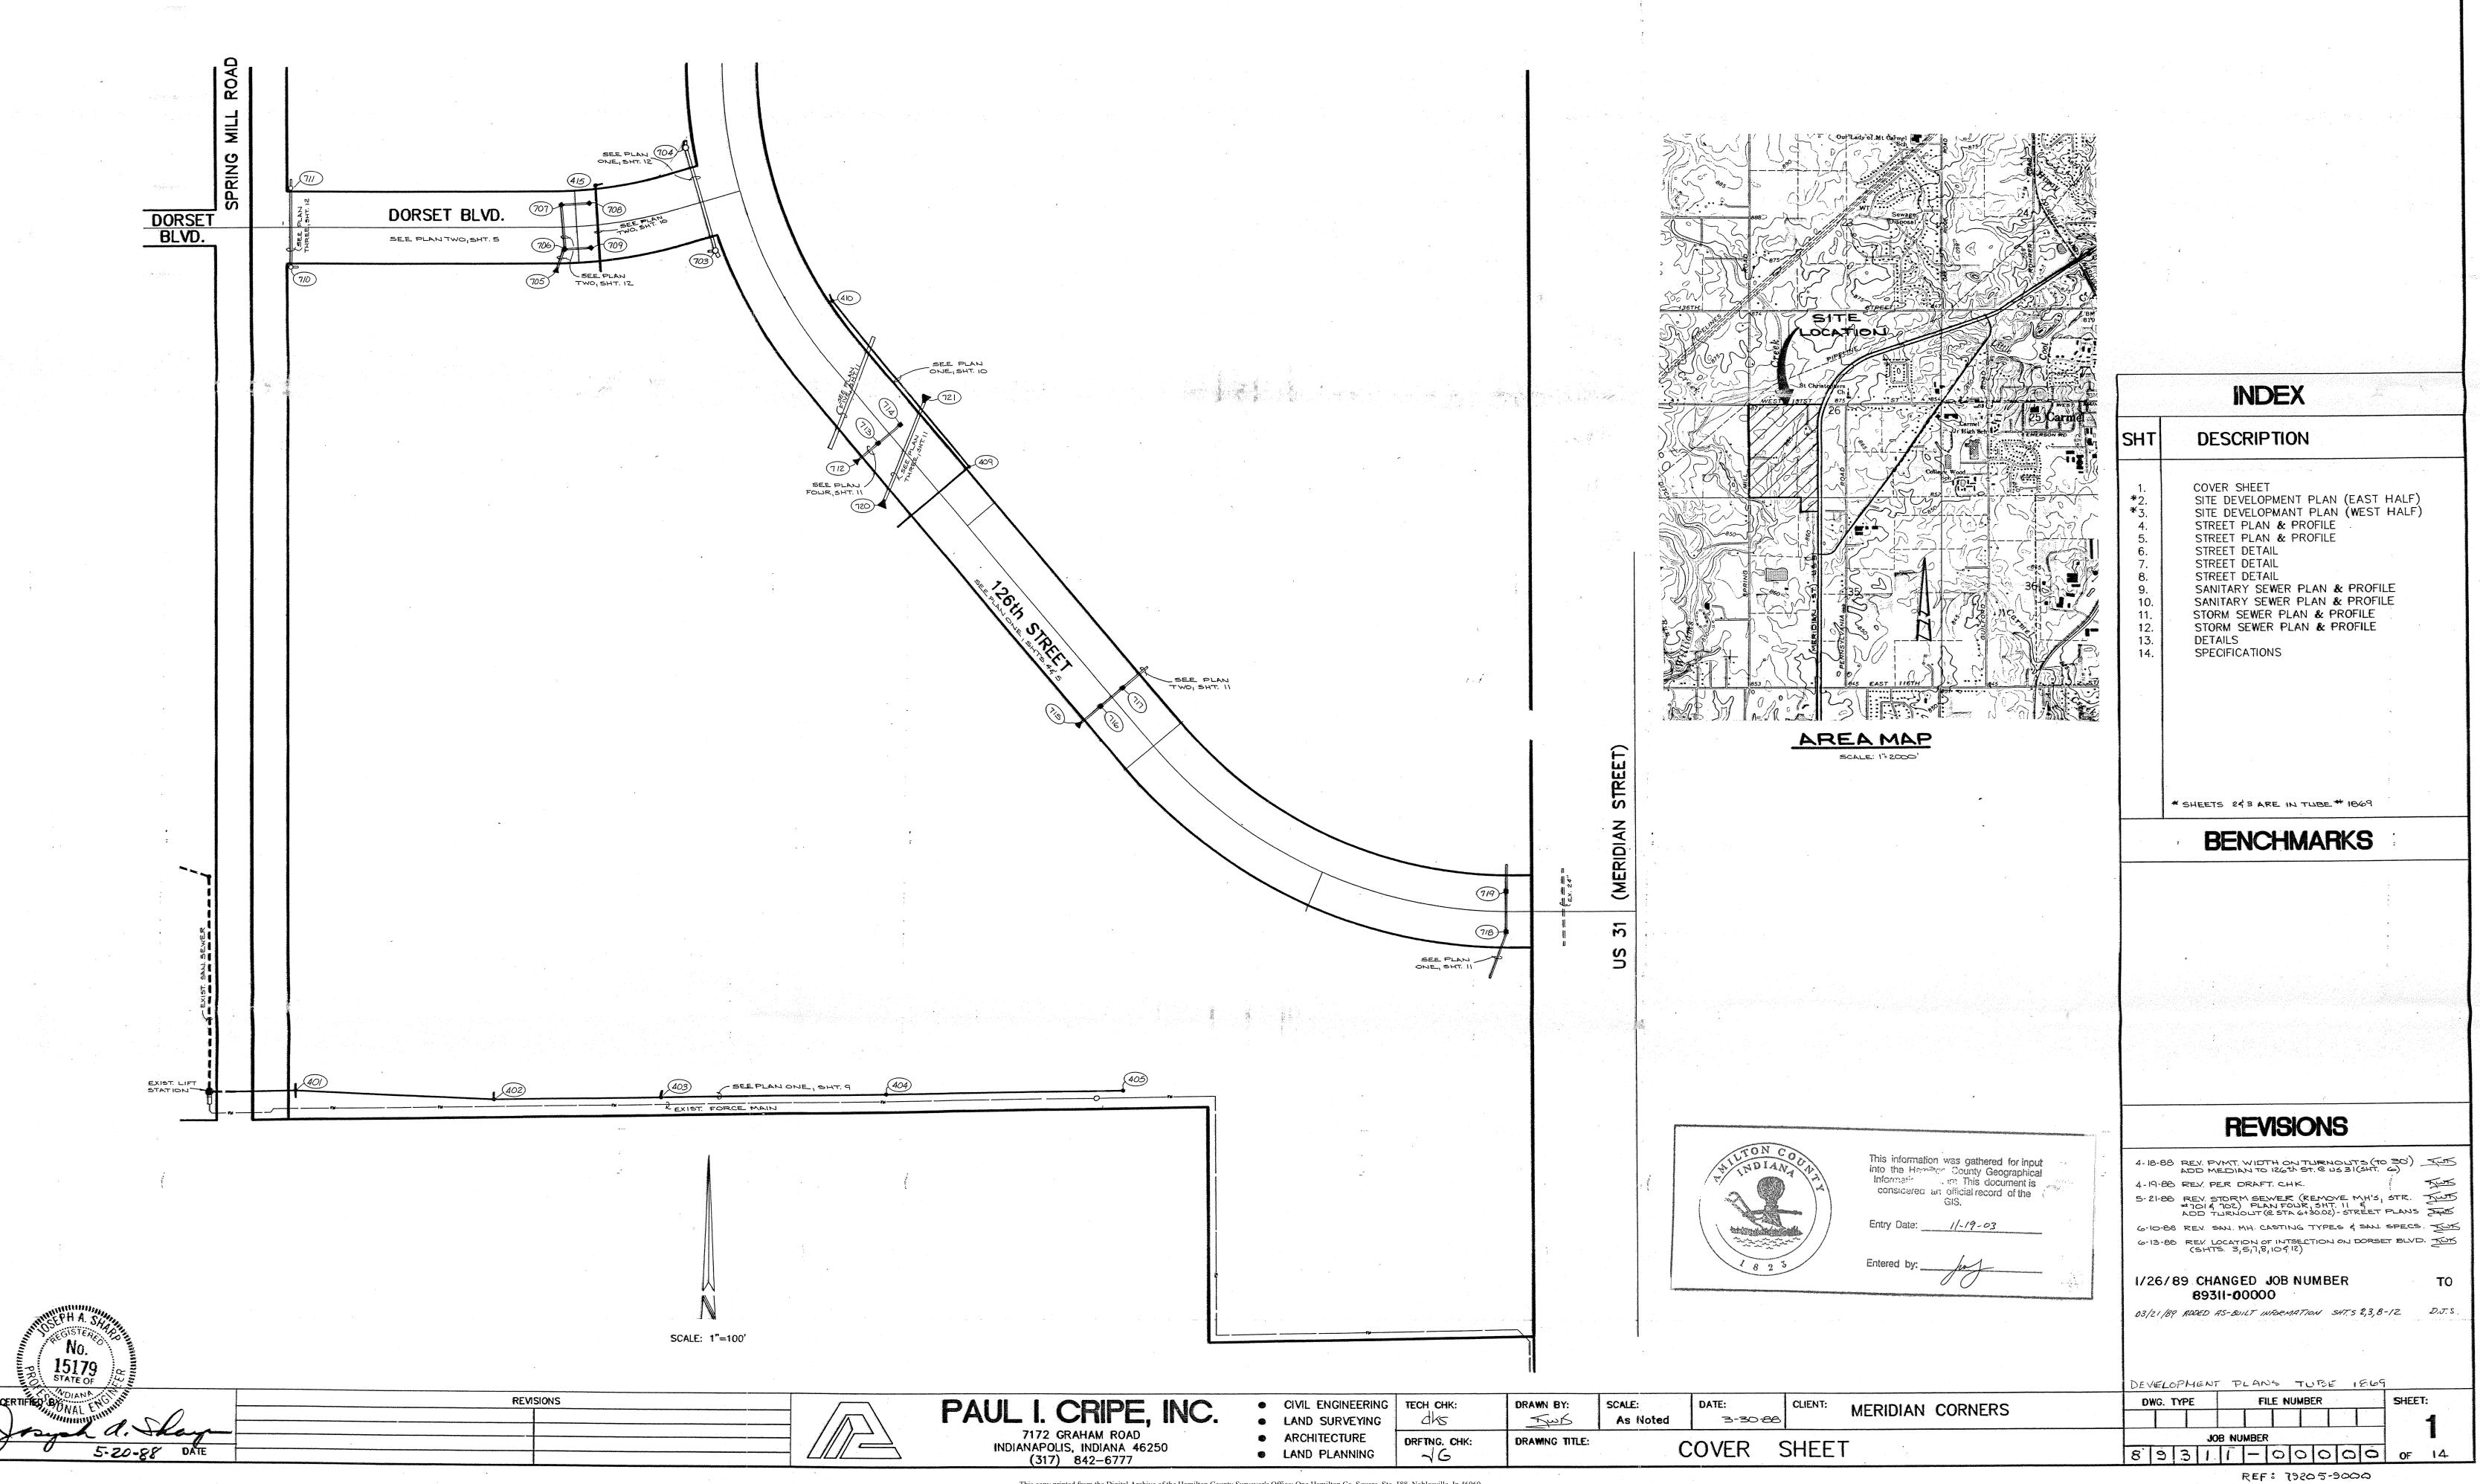

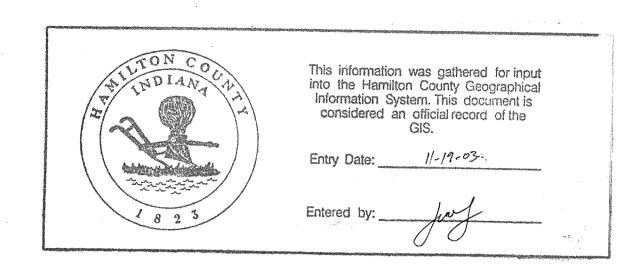

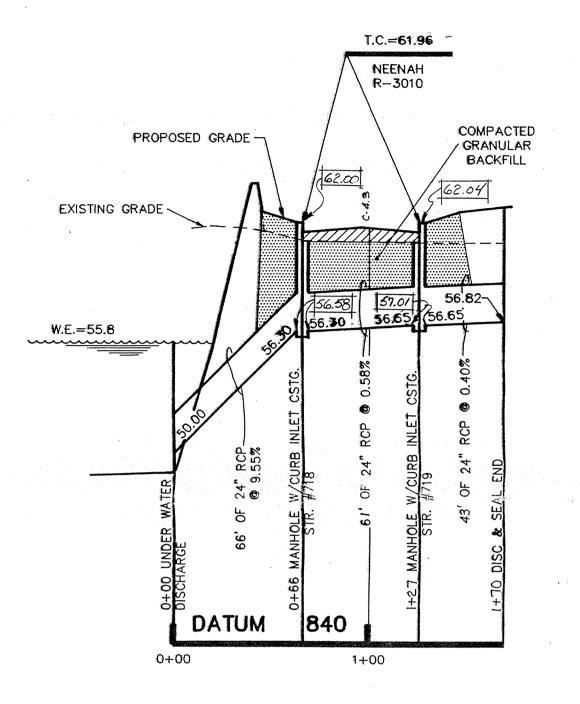


PROFILE ONE


PROFILE TWO

PROFILE THREE

PROFILE FOUR

PROFILE FIVE

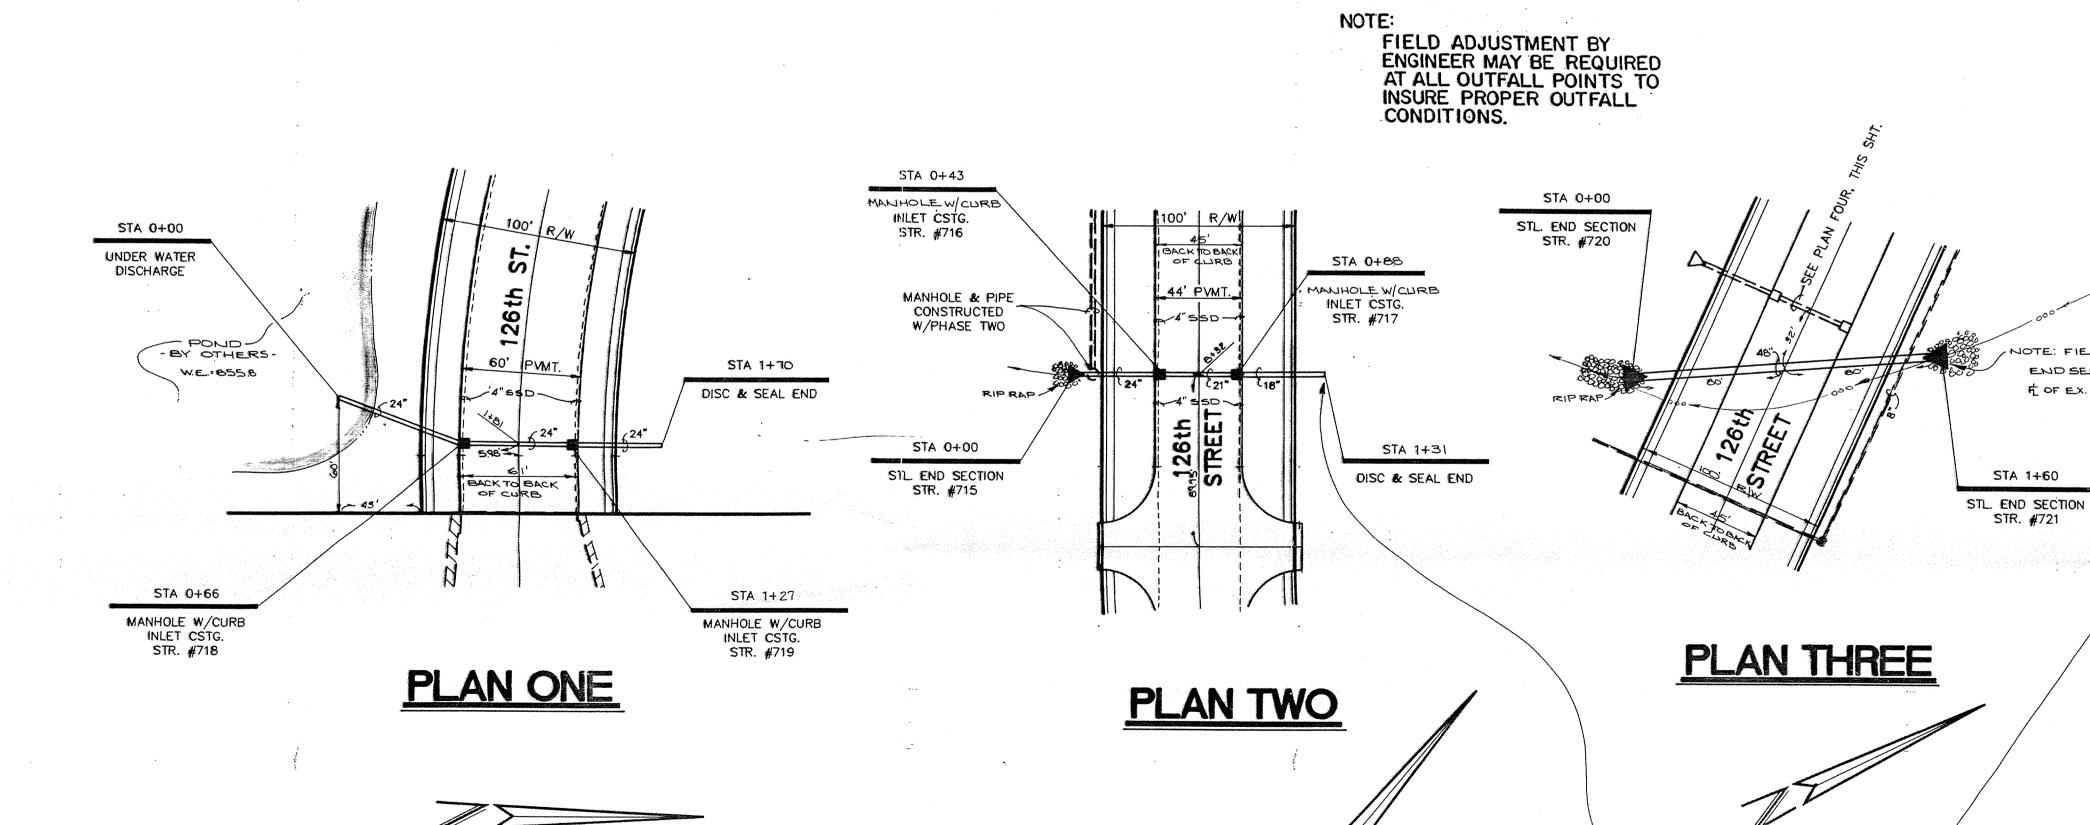

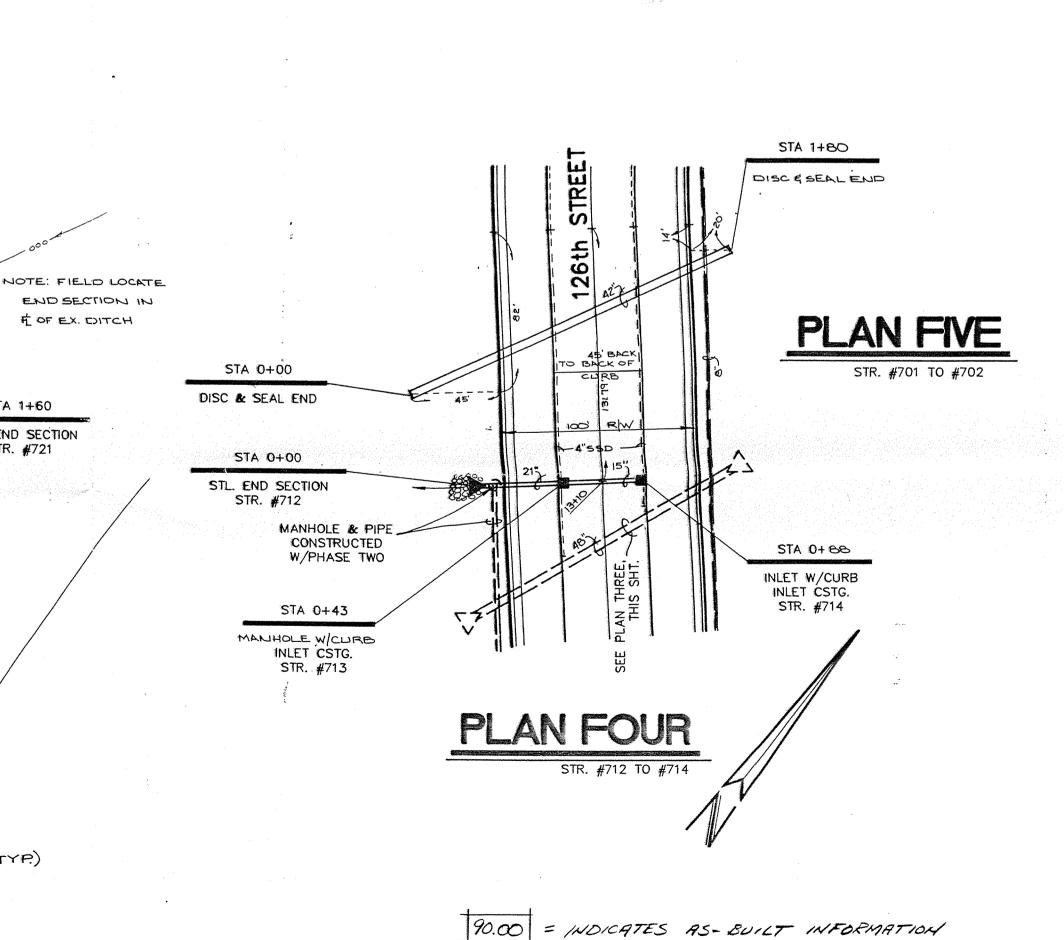

15179 STATE OF CERTIFIED BY

McDowell/James Printing, Inc.

5-20.88 DATE

REVISIONS 5-21-BB REV. P-4 - REMOVE MH'S TWK 03/21/89 ADDED AS BUILT INFORMATION D.J.S.

PAUL I. CRIPE, INC.
7172 GRAHAM ROAD
INDIANAPOLIS, INDIANA 46250
[317] 842-6777

CIVIL ENGINEERINGLAND SURVEYINGARCHITECTURELAND PLANNING

TECH. CHK. DRAWN BY

CONTRACTOR SHALL PLACE A

GREEN PAINTED STEEL FENCE POST & FINISH GRADE DIRECTLY

ABOVE ENDS OF ALL STORM SEWERS. (TYP.)

Trus


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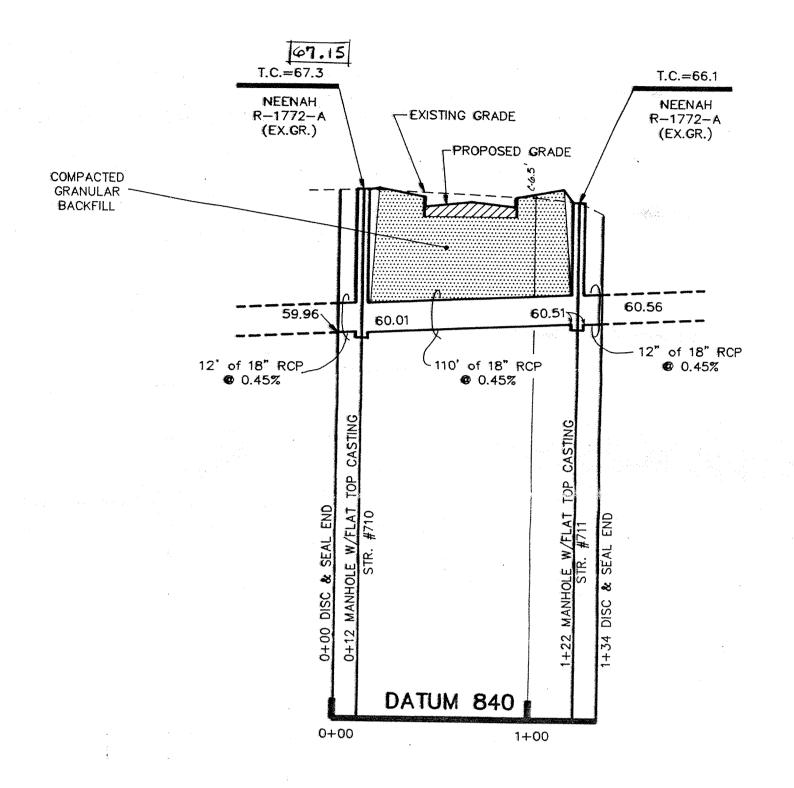
CLIENT

MERIDIAN CORNERS-PHASE 1 DFTNG. CHK. DRAWING TITLE STORM SEWER-PLAN & PROFILE 89311

DWG. TYPE JOB NUMBER


SHEET



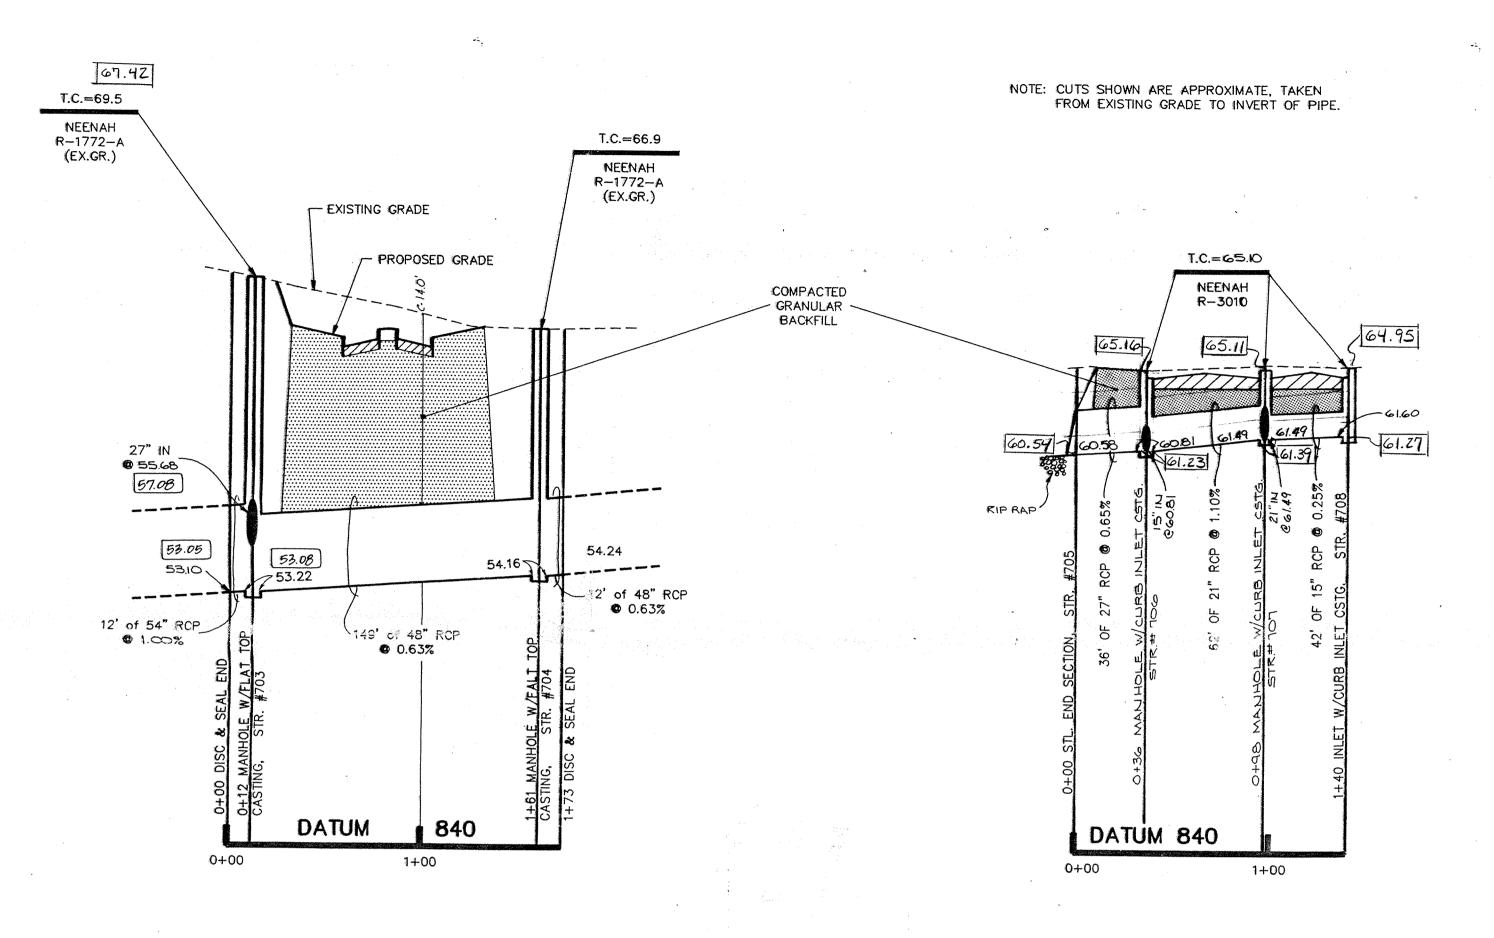

PROFILE TWO

PROFILE THREE

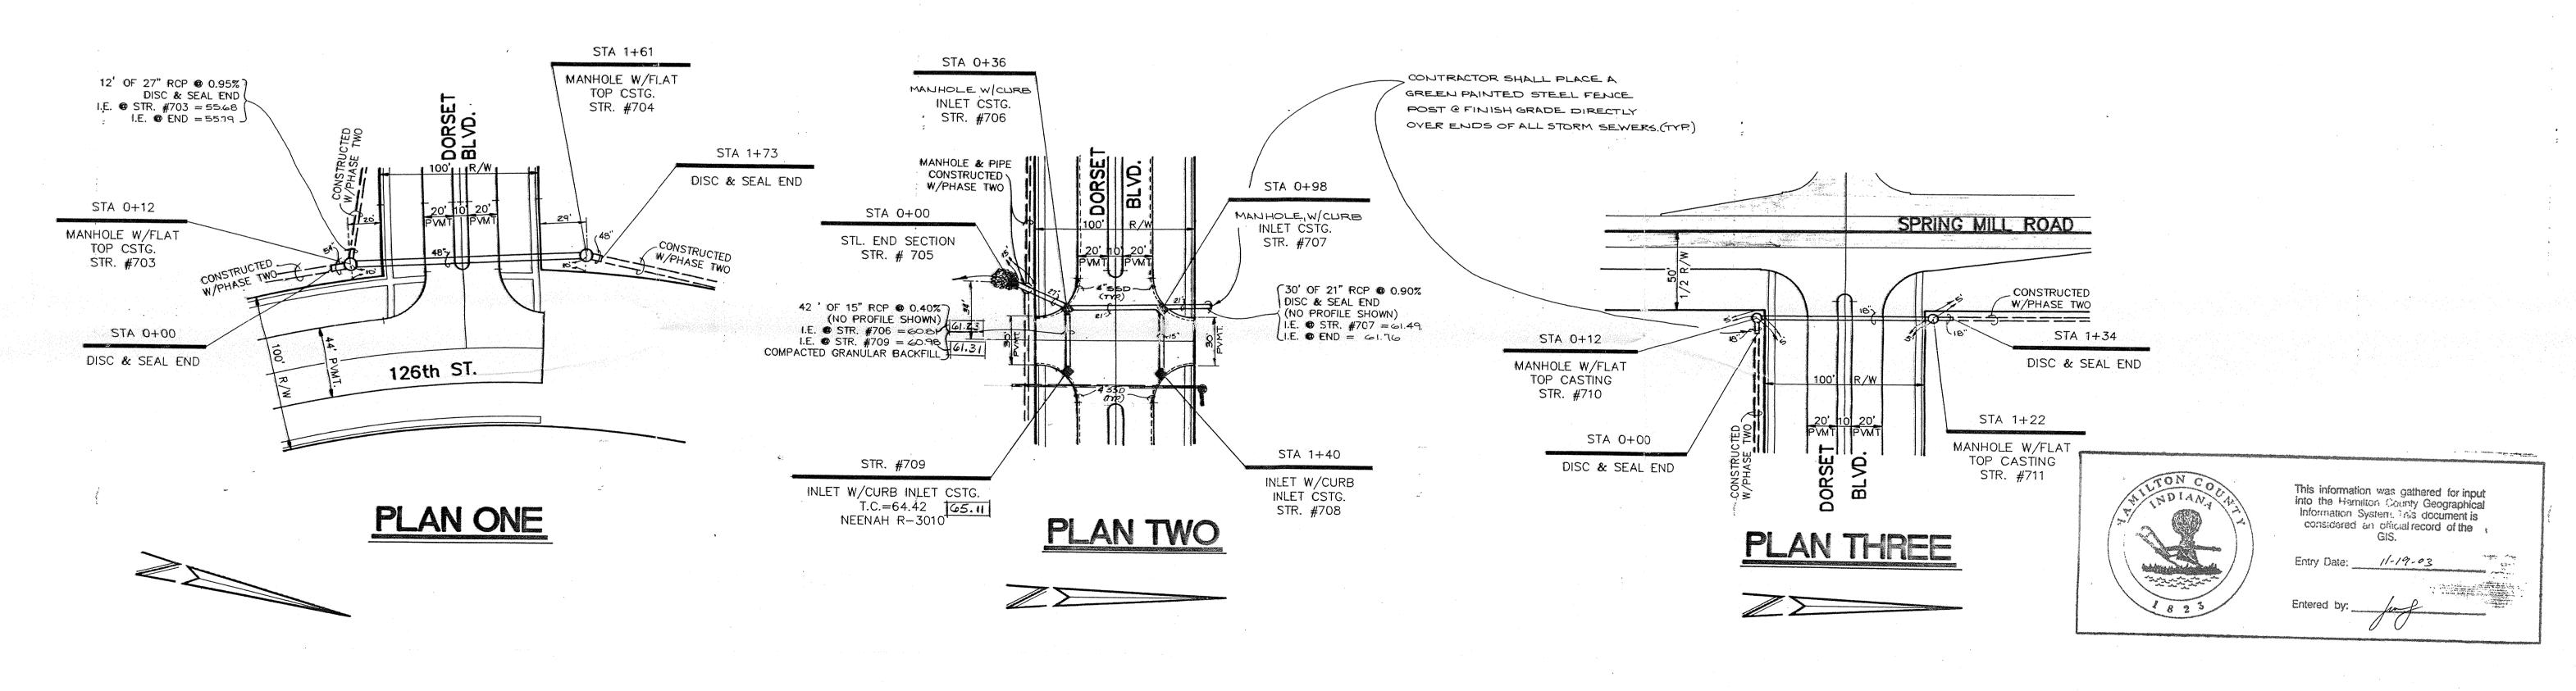

99,00 INDICATES AS-BUILT INFORMATION

-13-88 REV. PER DRAFT. CHK. TWK 4 REV. 27" STUB I.E. IN STR.# 703 5.20.88 DATE 03/21/89 ADDED AS-BUILT INFORMATION D.J.S. McDowell/James Printing, Inc.

REVISIONS

-19-88 REV. PER DRAFT. CHK.

15179 STATE OF

CEAMFLE DABY

PAUL I. CRIPE, INC. 7172 GRAHAM ROAD INDIANAPOLIS, INDIANA 46250 (317) 842-6777

• CIVIL ENGINEERING • LAND SURVEYING • ARCHITECTURE • LAND PLANNING


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MERIDIAN CORNERS-PHASE 1 3-30-68 DFTNG. CHK. DRAWING TITLE


STORM SEWER-PLANE PROFILE


DWG. TYPE FILE NUMBER JOB NUMBER

SHEET

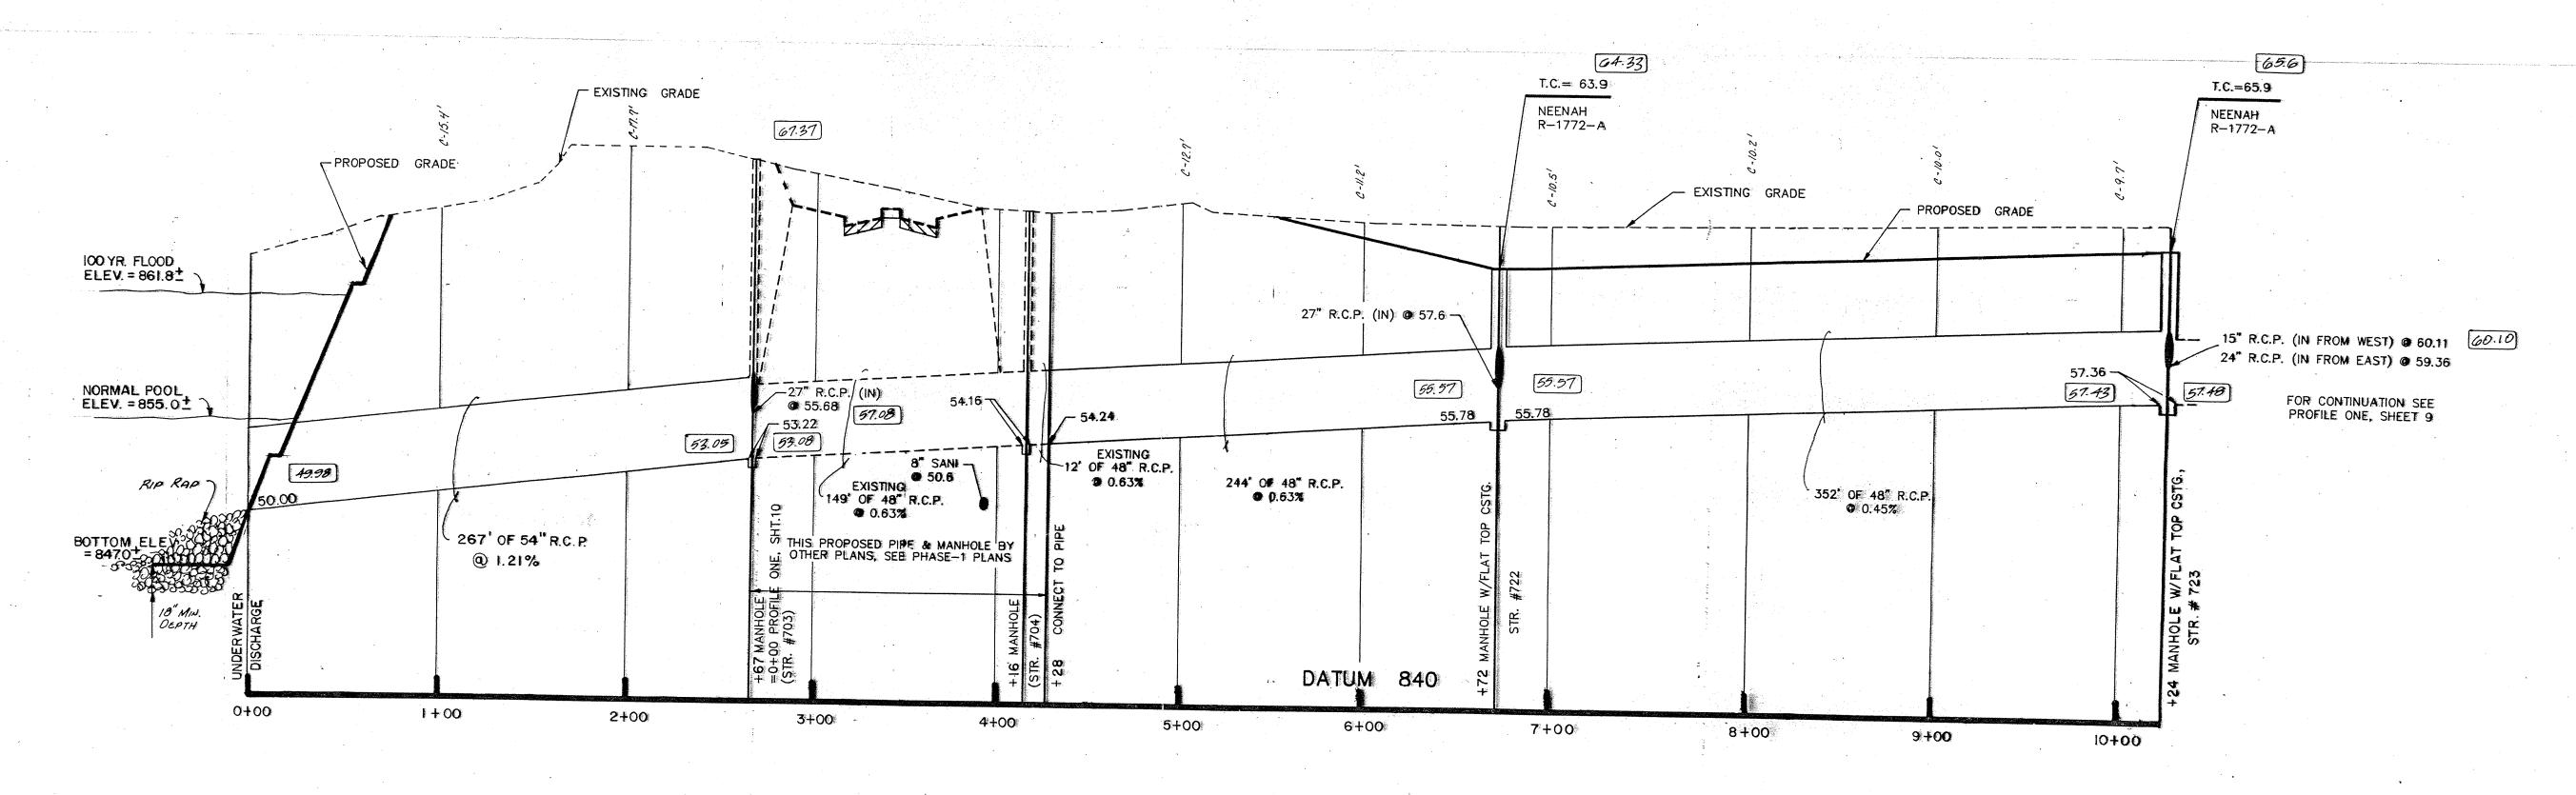

00.00 AS-BUILT INFORMATION

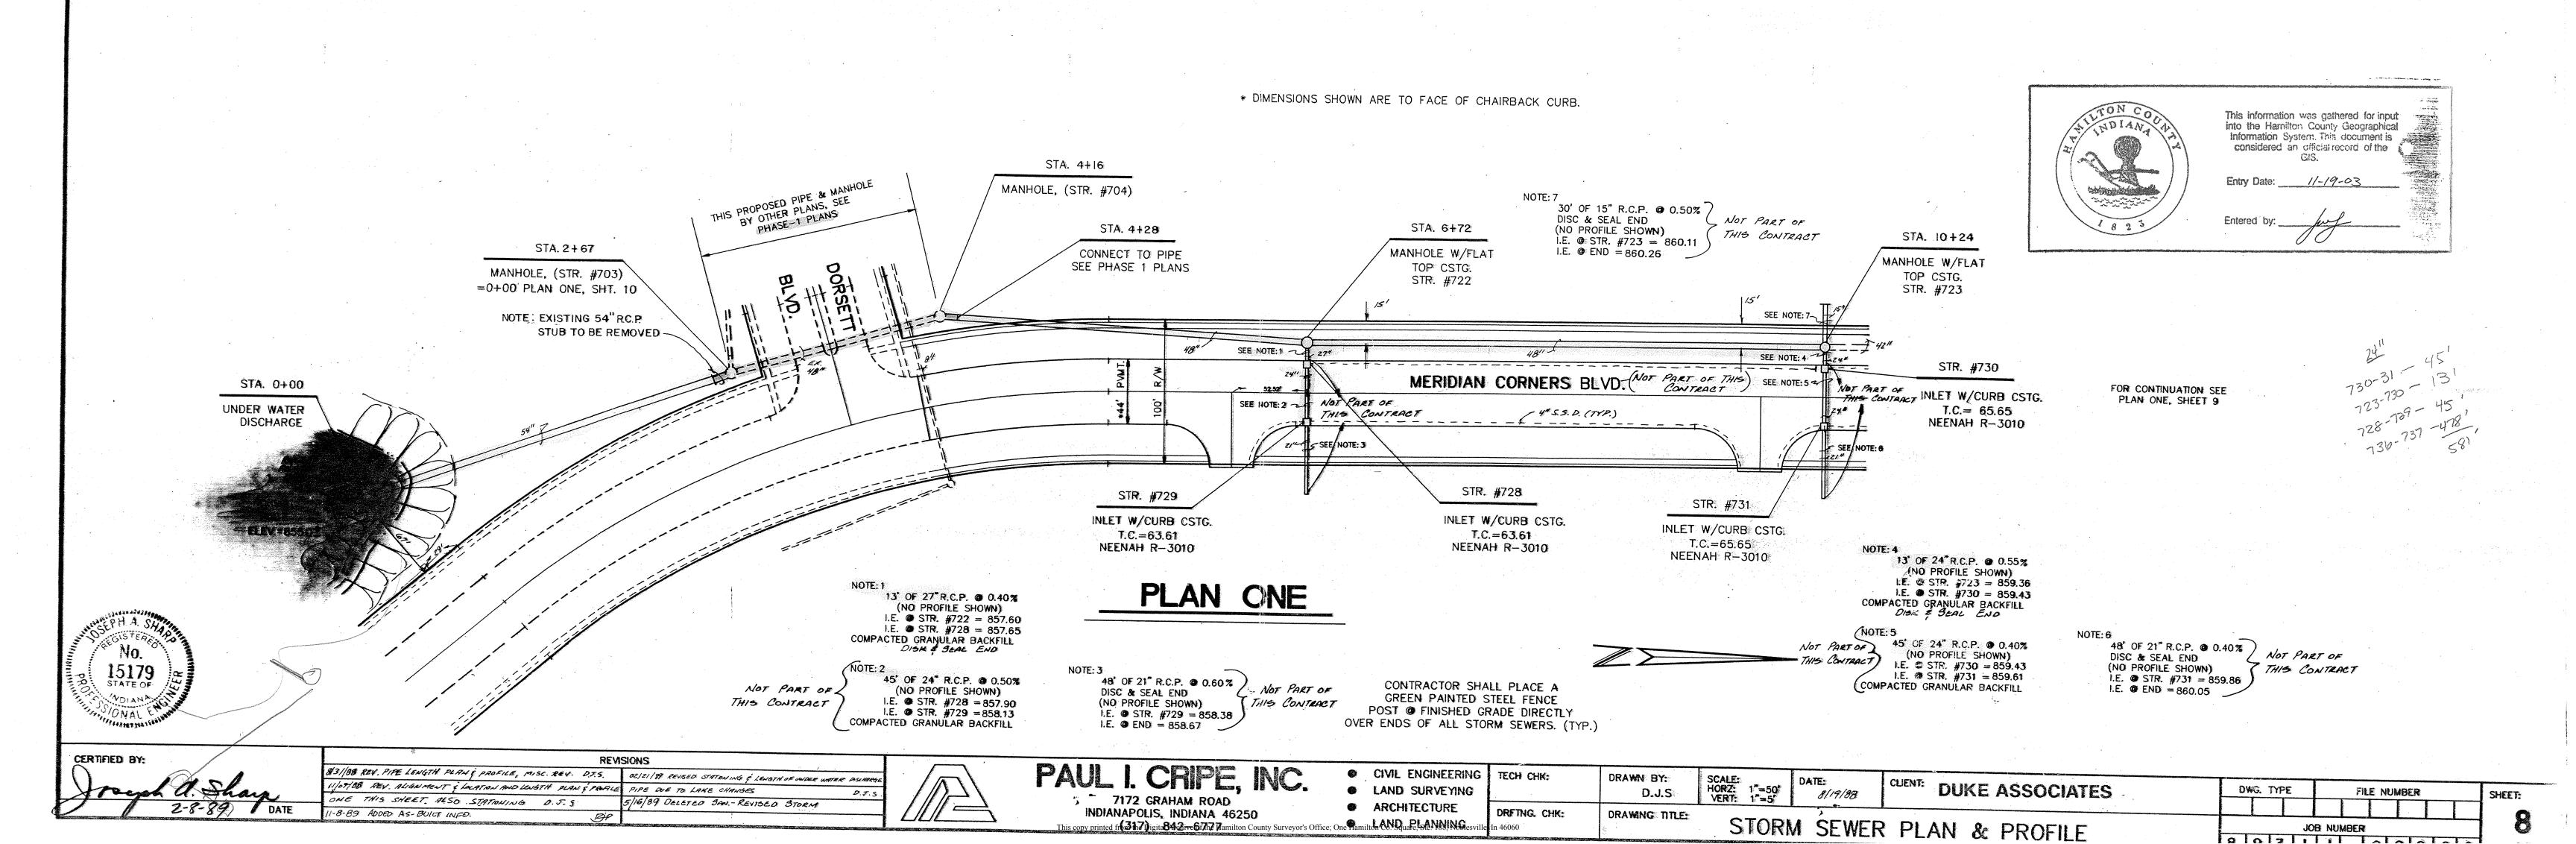

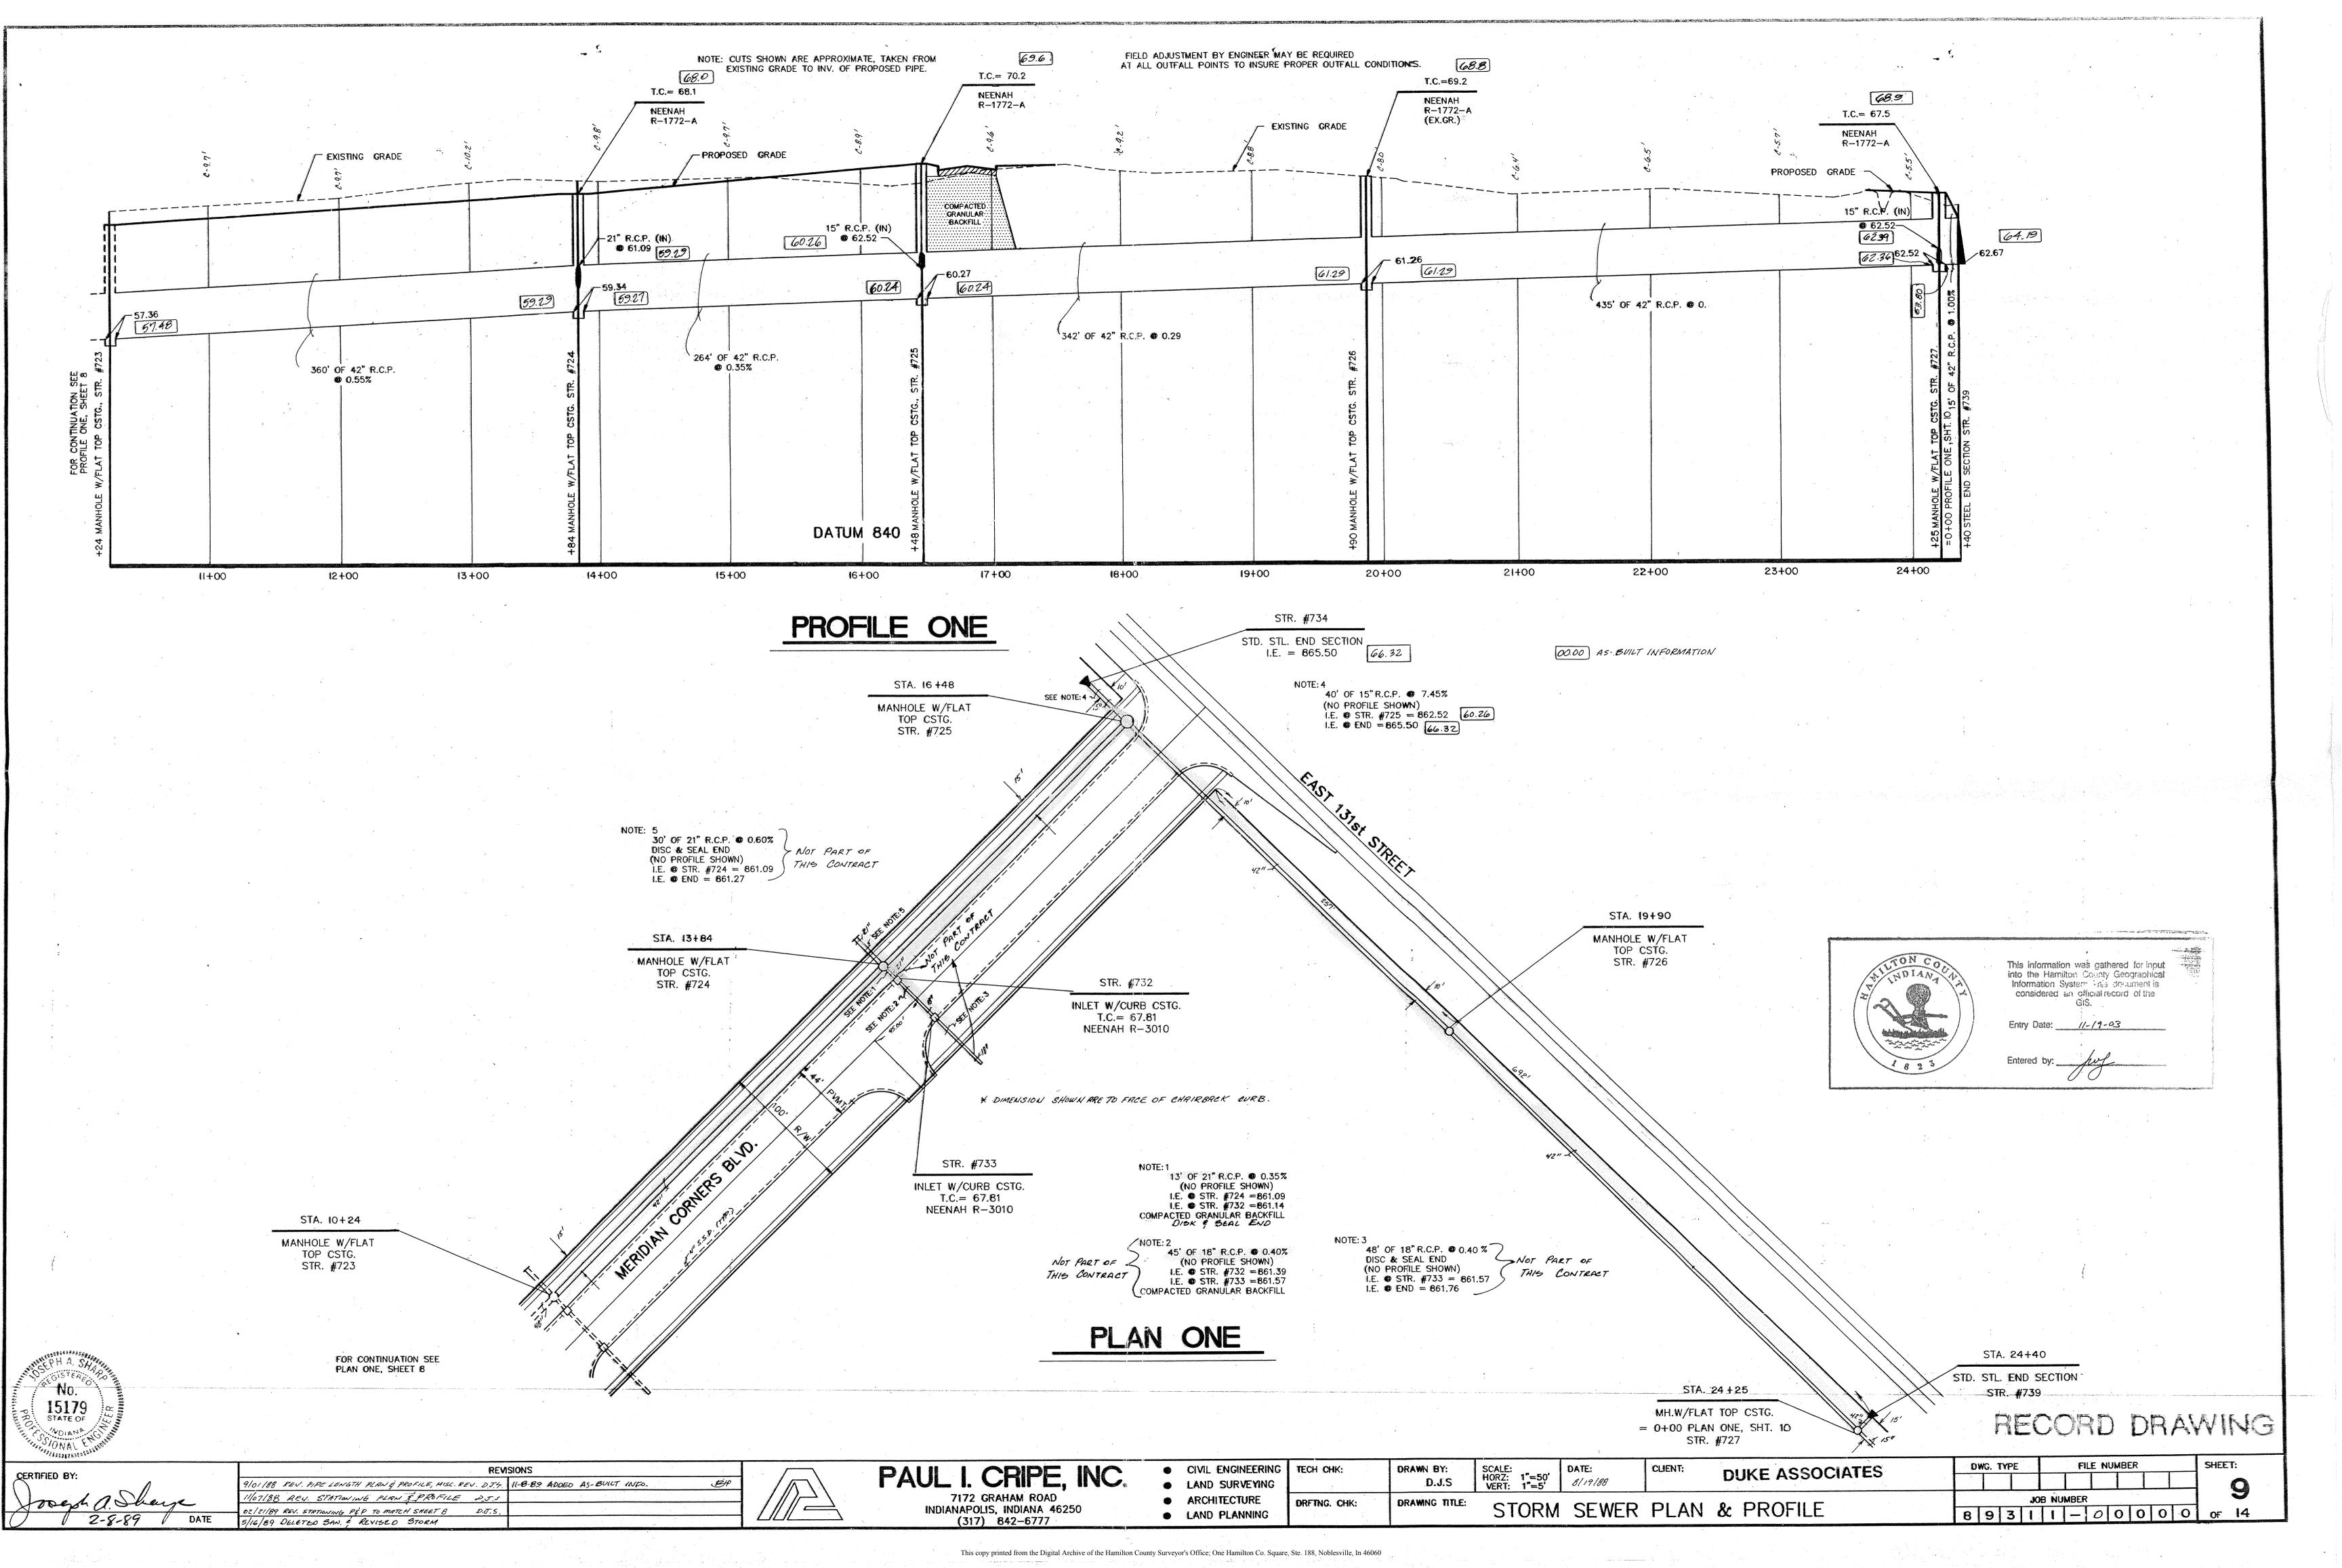


NOTE: CUTS SHOWN ARE APPROXIMATE, TAKEN FROM EXISTING GRADE TO INV. OF PROPOSED PIPE. FIELD ADJUSTMENT BY ENGINEER MAY BE REQUIRED 66.3 T.C.=66.8 NEENAH R-1772-A (EX.GR.) PROPOSED GRADE EXISTING GRADE -T.C.= 62.5± MANHOLE BUILT OVER EX. 12" FIELD TILE IN @ 63.11 (I.E. TO 42" R.C.P. (OUT) **●** 62.52 NEENAH R-1772-A PROPOSED GRADE 62.36 62.52 62.39 BE FIELD VERIFIED PRIOR (63.27) TO CONSTRUCTION.) / 100 YR. FLOOD ELEV. = 861.8 ± -EXISTING GRADE 390' OF 15" R.C.P. @ 0.15% *53.43* 53.50 SEE OFFSITE 53.1± DRAINAGE IMPROVEMENTS SEE SHEET -14 RIP-RAP 255' OF 36" R.C.P. @ 0.52% BOTTOM ELEV. = 847.0 1) DATUM 840 DATUM 840 0+00 1+00 2+00 3+00 0+00 1+00 2+00 PROFILE ONE PROFILE TWO 00.00 AS-BUILT INFORMATION CONTRACTOR SHALL VERIFY EXISTING INVERT ELEVATIONS PRIOR TO CONSTRUCTION OF SANITARY SEWERS. This information was gathered for input into the Hamilton County Geographical Information System. This document is considered an official record of the GIS. EAST 131st. STREET STA. 2+90 OTE: THIS MANHOLE TO BE BUILT OVER EXISTING 12" FIELD TILE I.E. & LOCATION TO BE FIELD STA. 0+00 STA. 2+55 MANHOLE W/FLAT TOP CSTG. STR. #742 END SECTION STR. #741 EXISTING 12" FIELD TILE
I.E.= 63.11 @ PROPOSED
MANHOLE LOCATION. VERIFIED PRIOR TO CONSTRUCTION. NORMAL POOL ELEV. = 855.0+ 42"-15' SEE OFFSITE DRAINAGE IMPROVEMENTS SEE SHEET -14 -Z nit sq. Ynds RIP-RAP STA. 3+90 ₩~ EX. 12" MANHOLE W/FLAT TOP CSTG. STR. #740 STA. 0+00 MANHOLE W/FLAT TOP CSTG. =24+25 PLAN ONE, SHEET 9 STR. #727 PLAN ONE PLAN TWO RECORD DRAWING REVISIONS PAUL I. CRIPE, INC. CERTIFIED BY: CIVIL ENGINEERING SCALE: HORZ: 1"=50' VERT: 1"=5' FILE NUMBER SHEET: TECH CHK: DRAWN BY: DWG. TYPE **DUKE ASSOCIATES** 02/21/89 REVISED LAKE SECTION PROFILE & PLAN TWO
11-8-89 ADDED HS-BUILT INFO. • LAND SURVEYING D.J.S 08/19/88 BHP | 7172 GRAHAM ROAD INDIANAPOLIS, INDIANA 46250 (317) 842-6777 ARCHITECTURE DRFTNG. CHK: DRAWING TITLE: JOB NUMBER STORM SEWER PLAN & PROFILE • LAND PLANNING 8 9 3 1 1 - 0 0 0 0 0 of 14

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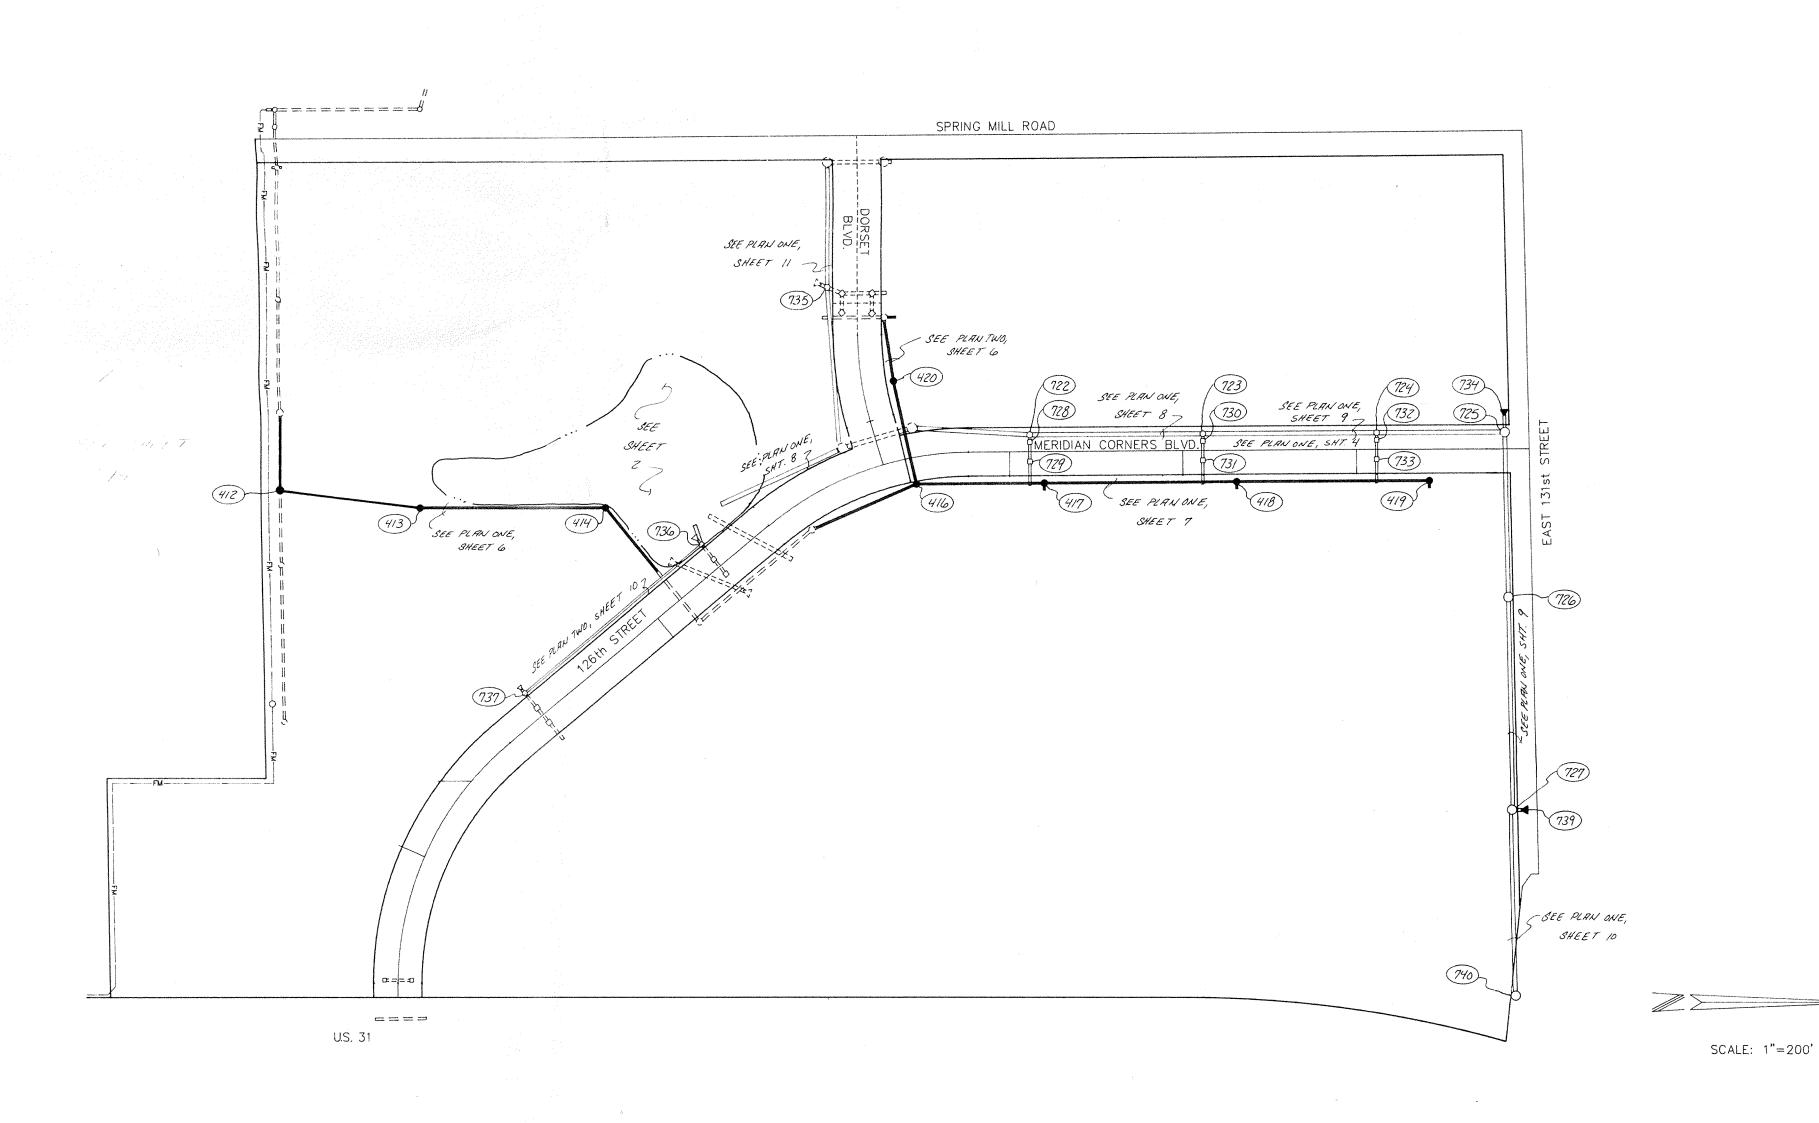
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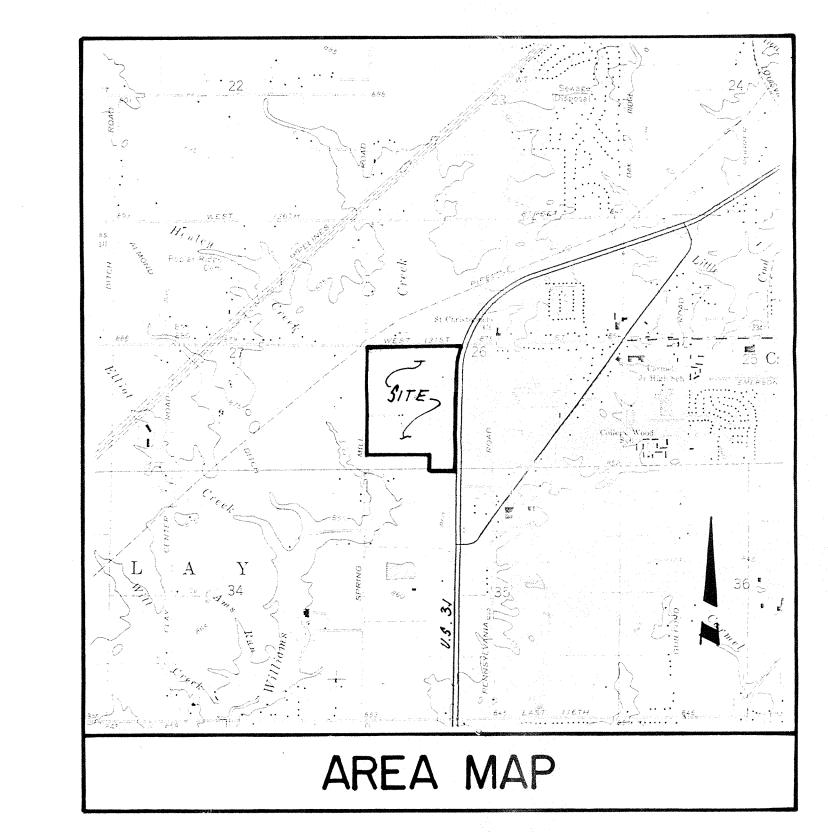
FIELD ADJUSTMENT BY ENGINEER MAY BE REQUIRED
AT ALL OUTFALL POINTS TO INSURE PROPER OUTFALL CONDITIONS.



CONSTRUCTION PLANS FOR MERIDIAN CORNERS-PHASE TWO

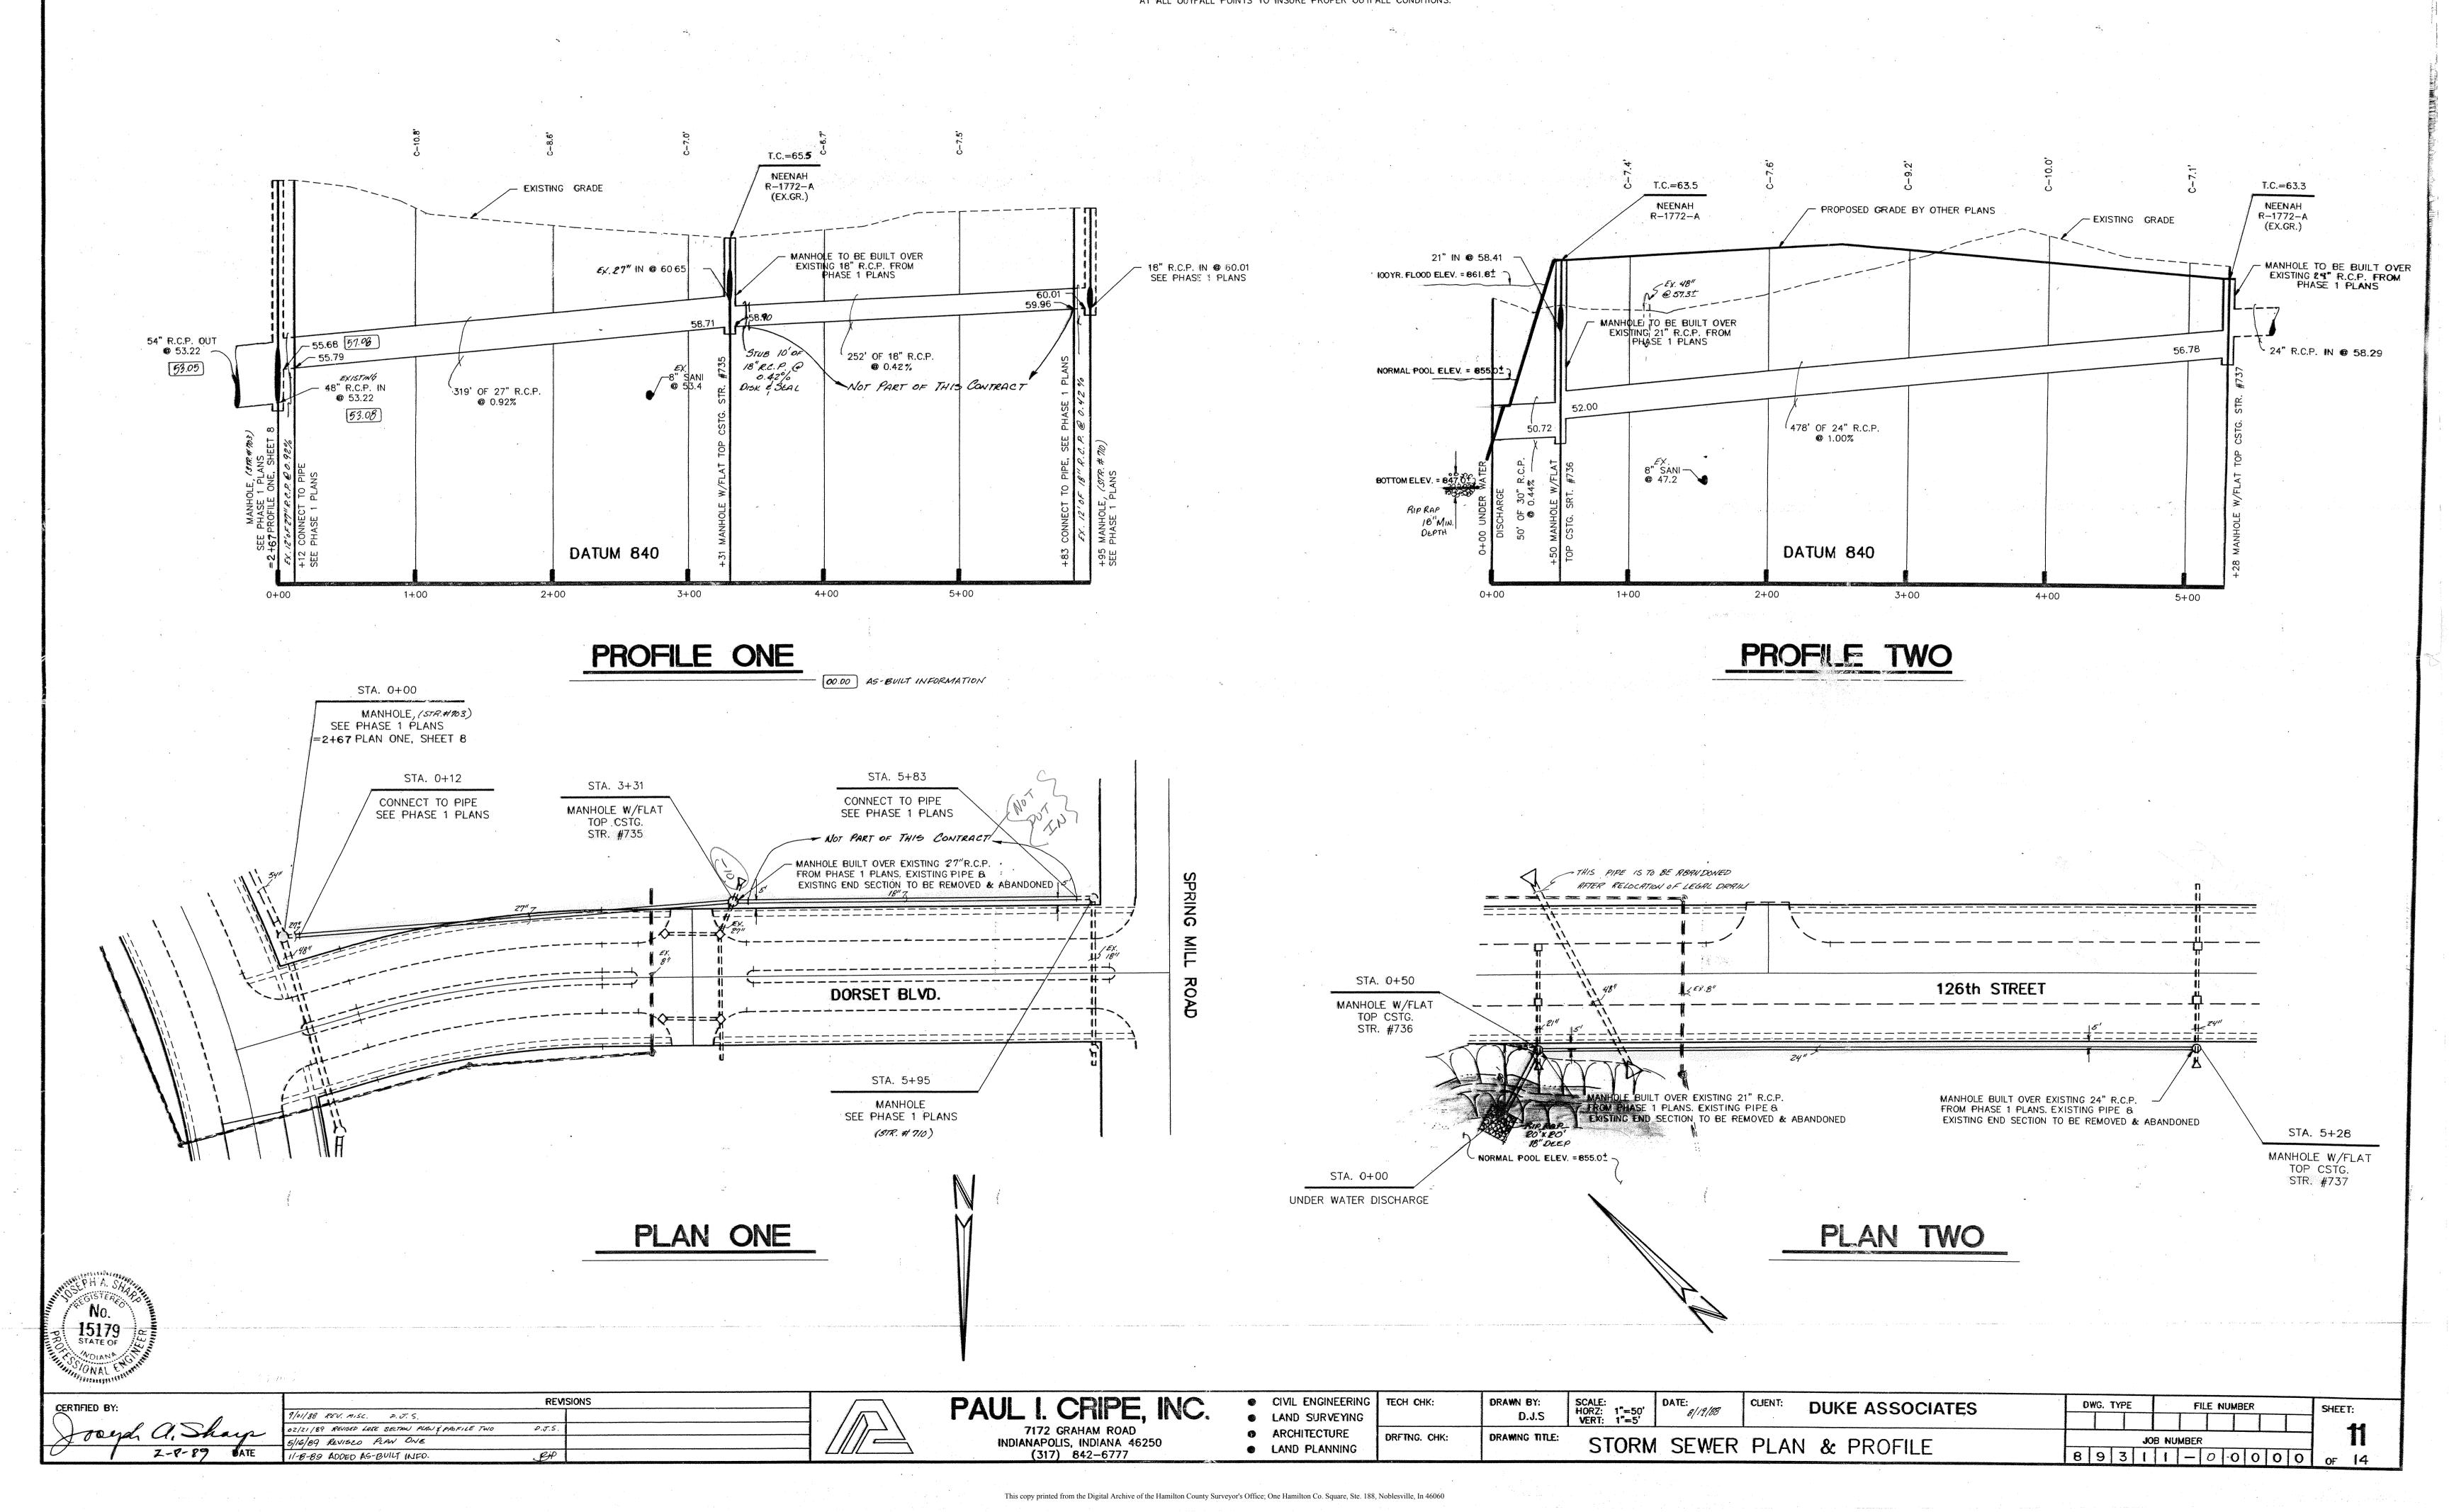





INDEX DESCRIPTION SITE DEVELOPMENT PLAN - NORTH END STREET PLAN & PROFILE DETAILS SPECIFICATIONS OFFSITE DRAINAGE IMPROVEMENTS

SITE WORK GENERAL NOTES AND SPECIFICATIONS

NOTICES AND PERMITS

A. THE CONTRACTOR SHALL BE RESPONSIBLE FOR OBTAINING, OR VERIFYING, THAT ALL PERMITS AND APPROVALS ARE OBTAINED FROM THE RESPECTIVE CITY, COUNTY AND STATE AGENCIES PRIOR TO STARTING CONSTRUCTION.

B. IT SHALL BE THE CONTRACTORS RESPONSIBILITY TO DETERMINE THE EXACT LOCATION OF ALL EXISTING UTILITIES IN THE VICINITY OF THE CONSTRUCTION AREA PRIOR TO STARTING CONSTRUCTION.


C. IT SHALL BE THE CONTRACTORS RESPONSIBILITY FOR NOTIFICATION AND COORDINATION OF ALL CONSTRUCTION WITH RESPECTIVE UTILITY COMPANIES.


D. IT SHALL BE THE RESPONSIBILITY OF THE DEVELOPER AND CONTRACTOR TO MAINTAIN QUALITY CONTROL THROUGHOUT THE PROJECT; FAILURE TO DO SO MAY RESULT IN REMOVAL AND REPLACEMENT OF THE DEFECTIVE WORK, IT IS RECOMMENDED THAT THE DEVELOPER HAVE A QUALIFIED INSPECTOR ON THE JOB SITE AT ALL TIMES DURING CONSTRUCTION.

E. IT IS ESSENTIAL THAT THE WORK TO BE DONE IN CONJUNCTION WITH THIS PROJECT SHALL BE INSTALLED ACCORDING TO THESE SPECIFICATIONS. THE ENGINEER WILL BE REQUIRED TO CERTIFY TO CERTAIN PORTIONS OF THIS PROJECT UPON COMPLETION. THEREFORE, IT IS NECESSARY TO OBTAIN APPROVAL AND ACCEPTANCE BY THE CITY THAT CONSTRUCTION WAS DONE IN COMPLIANCE WITH THESE PLANS AND SPECIFICATIONS.

REVISIONS

BENCHMARKS

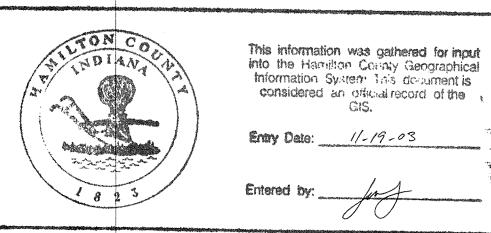

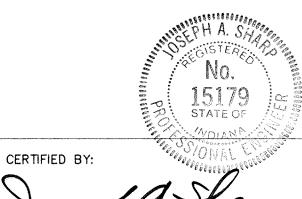

REVISIONS 8/31/88 ADDED AREA MAP

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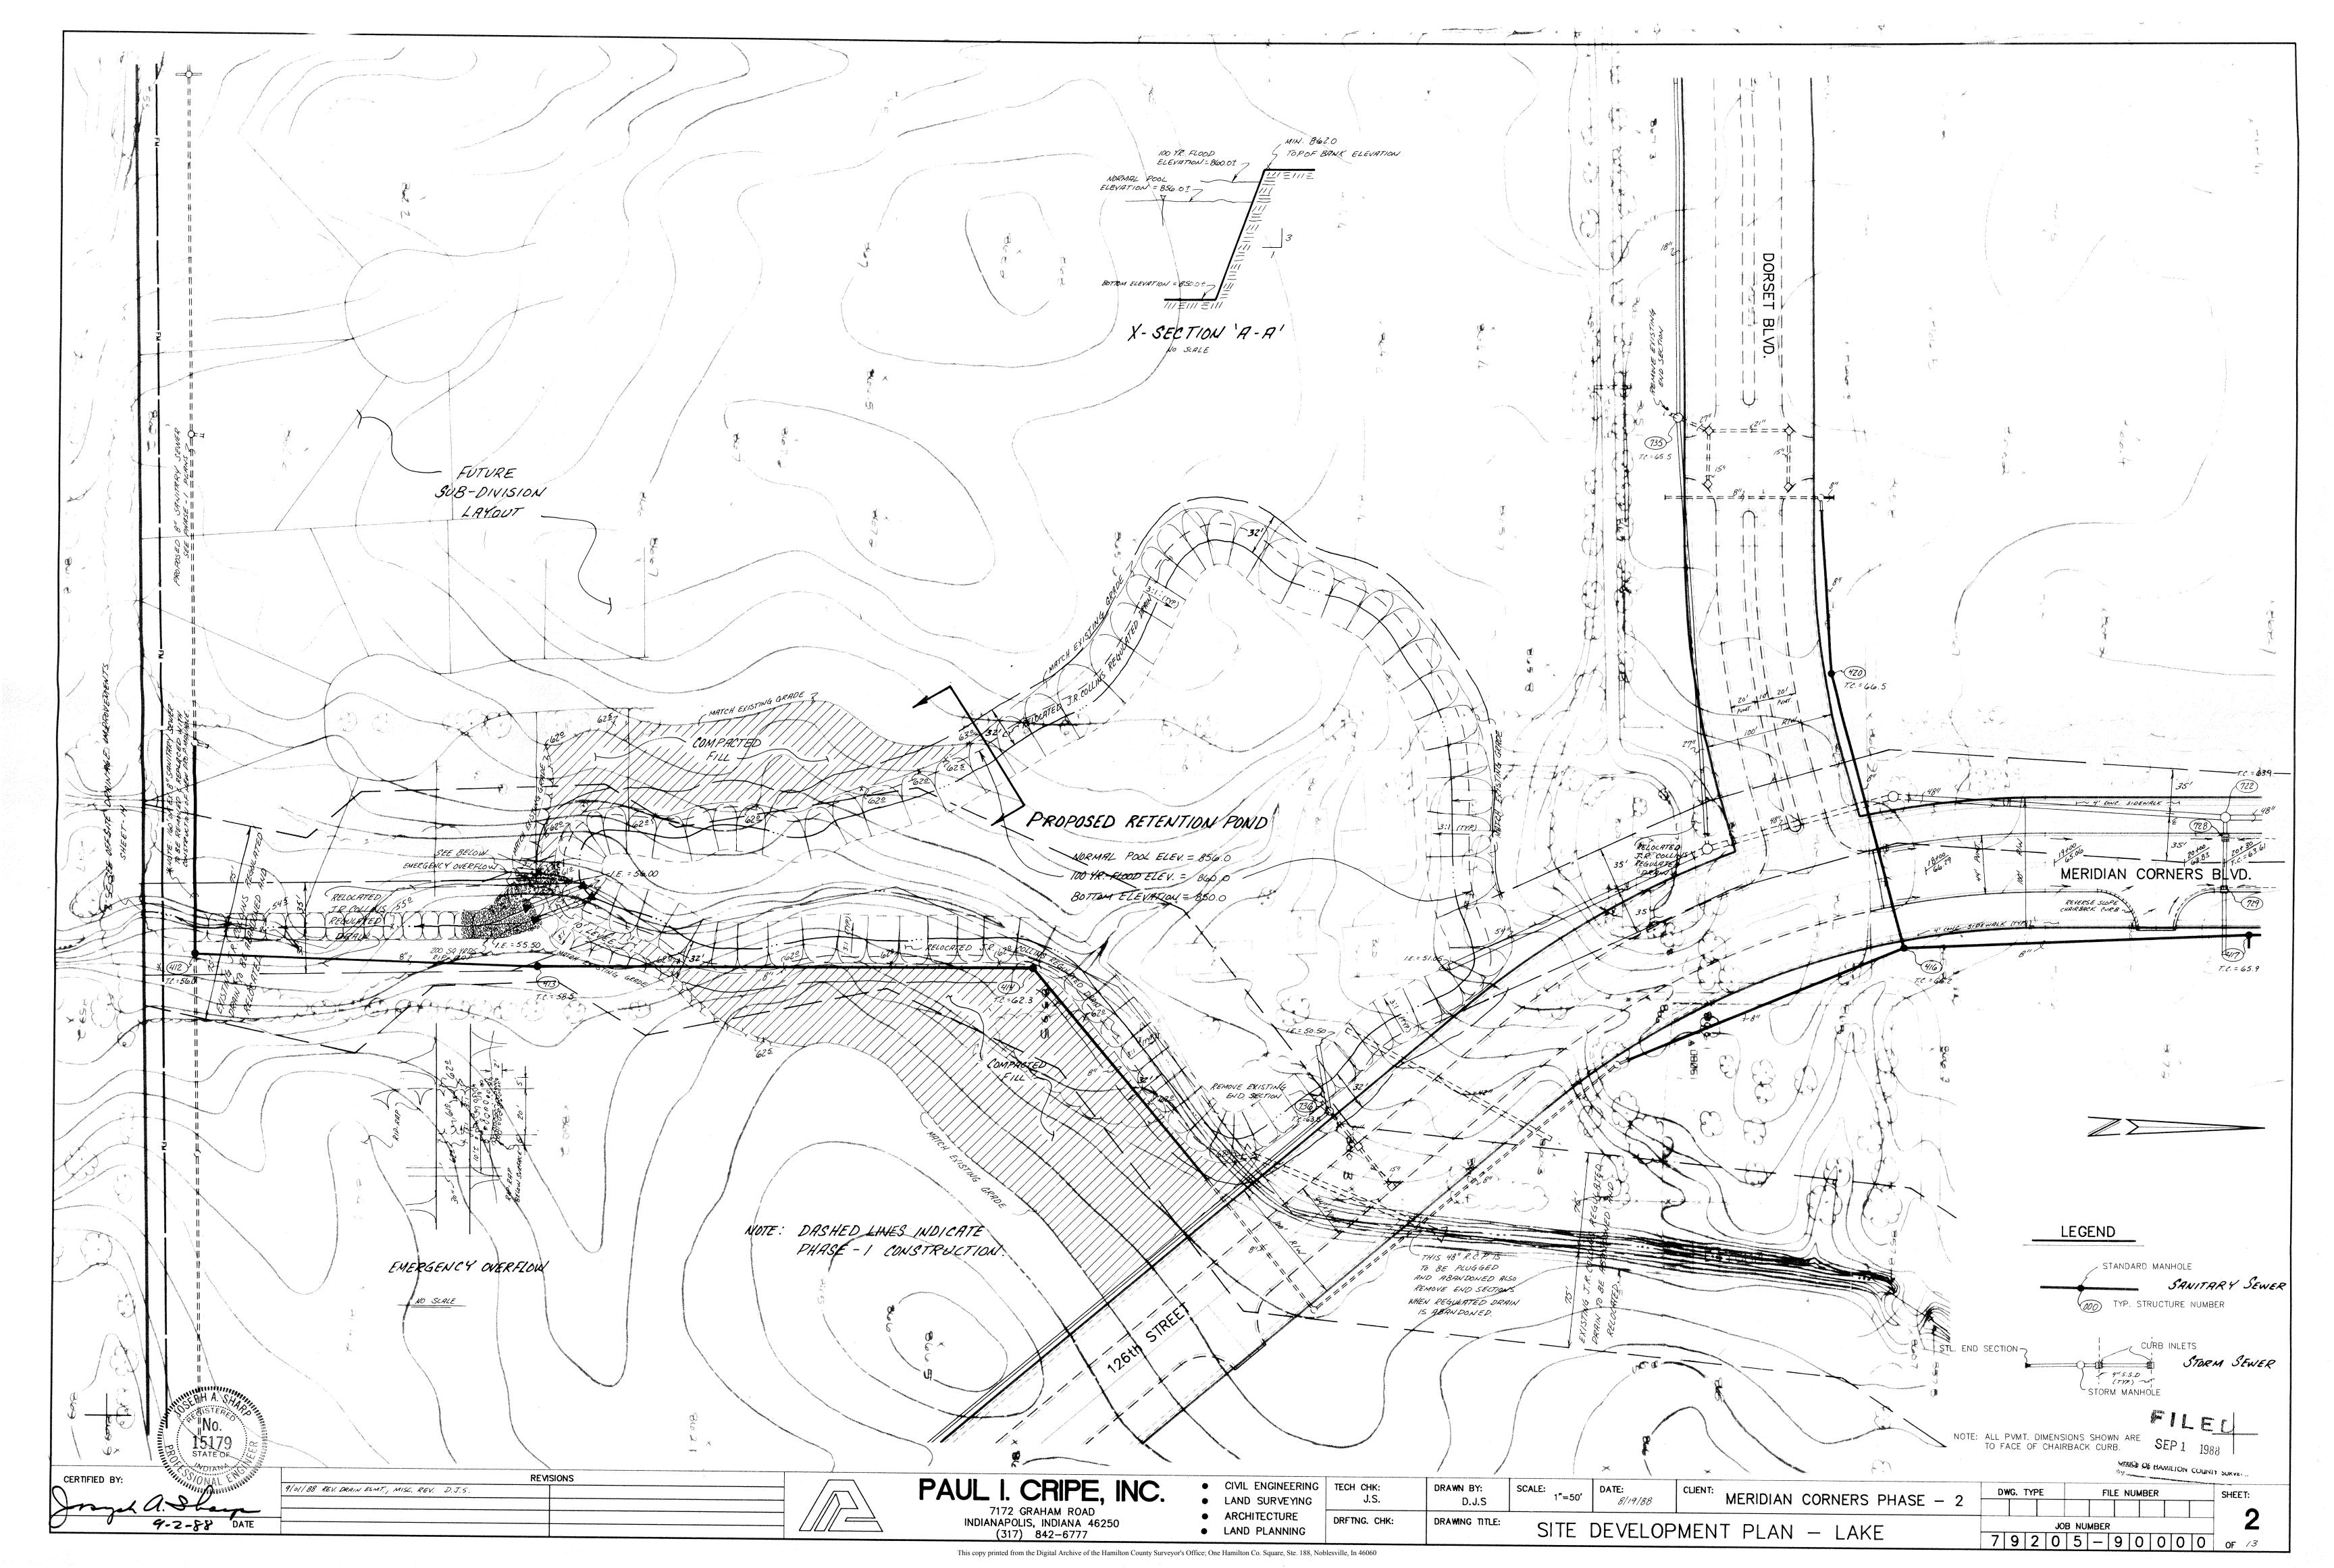
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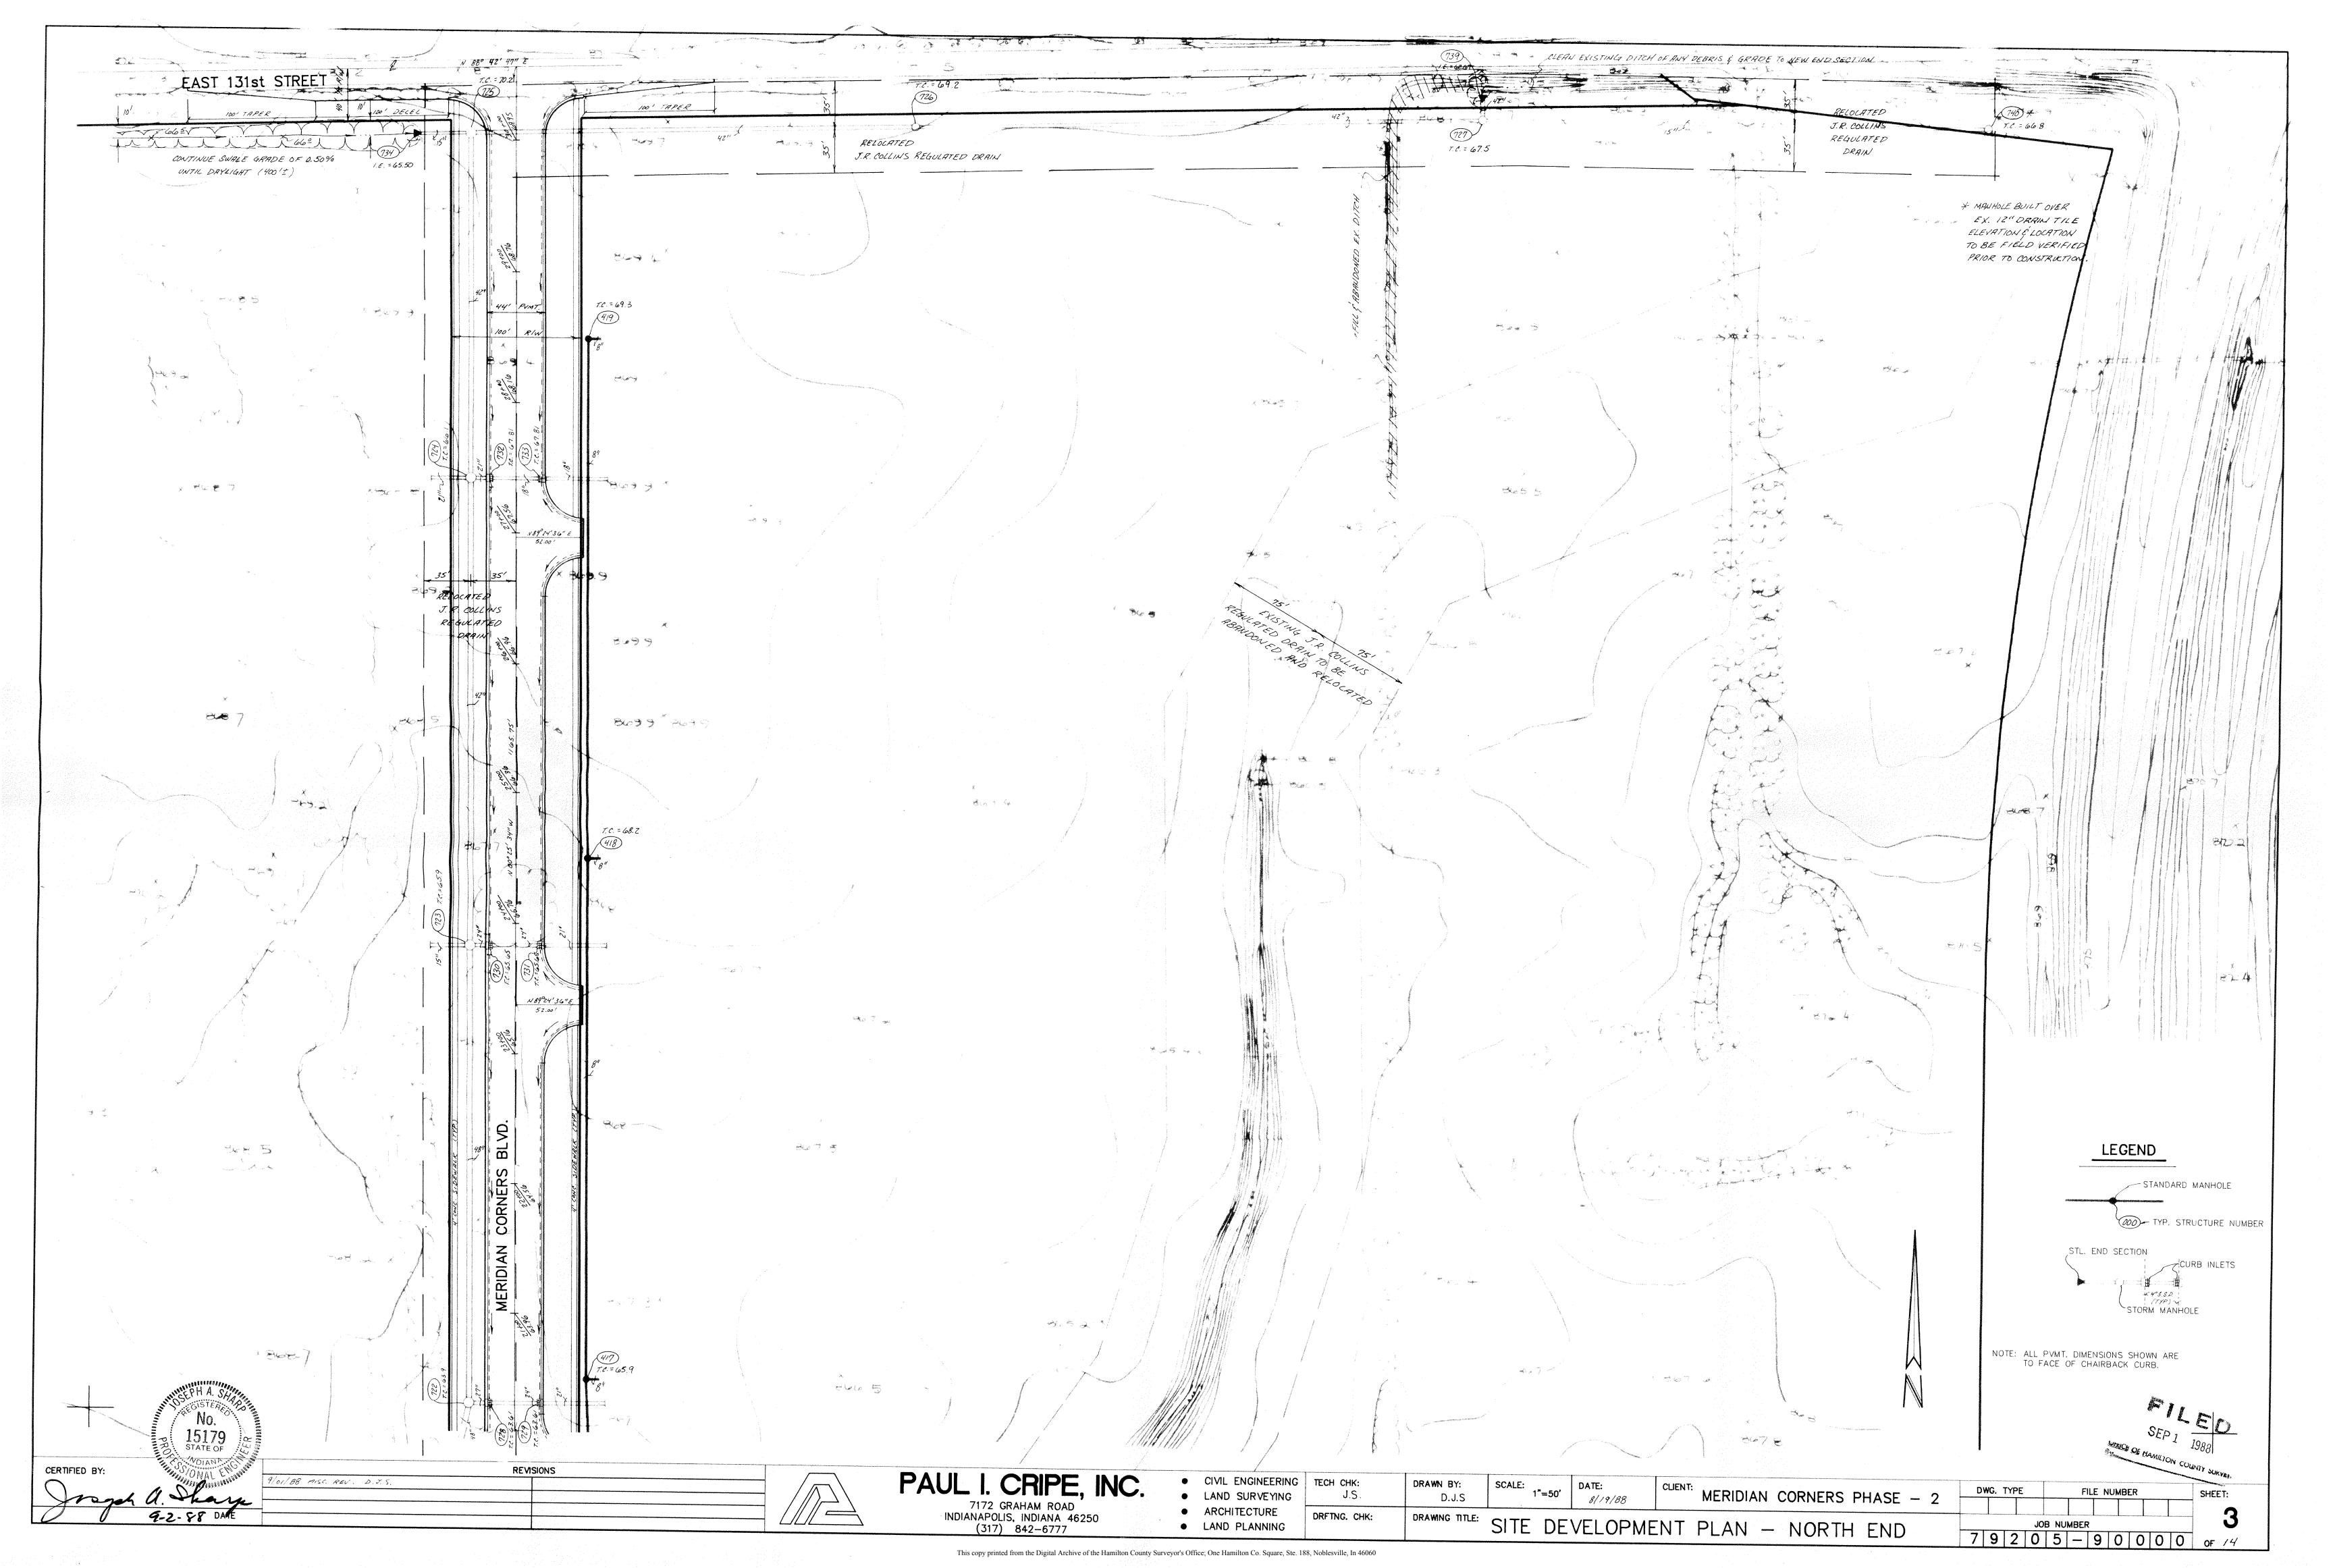
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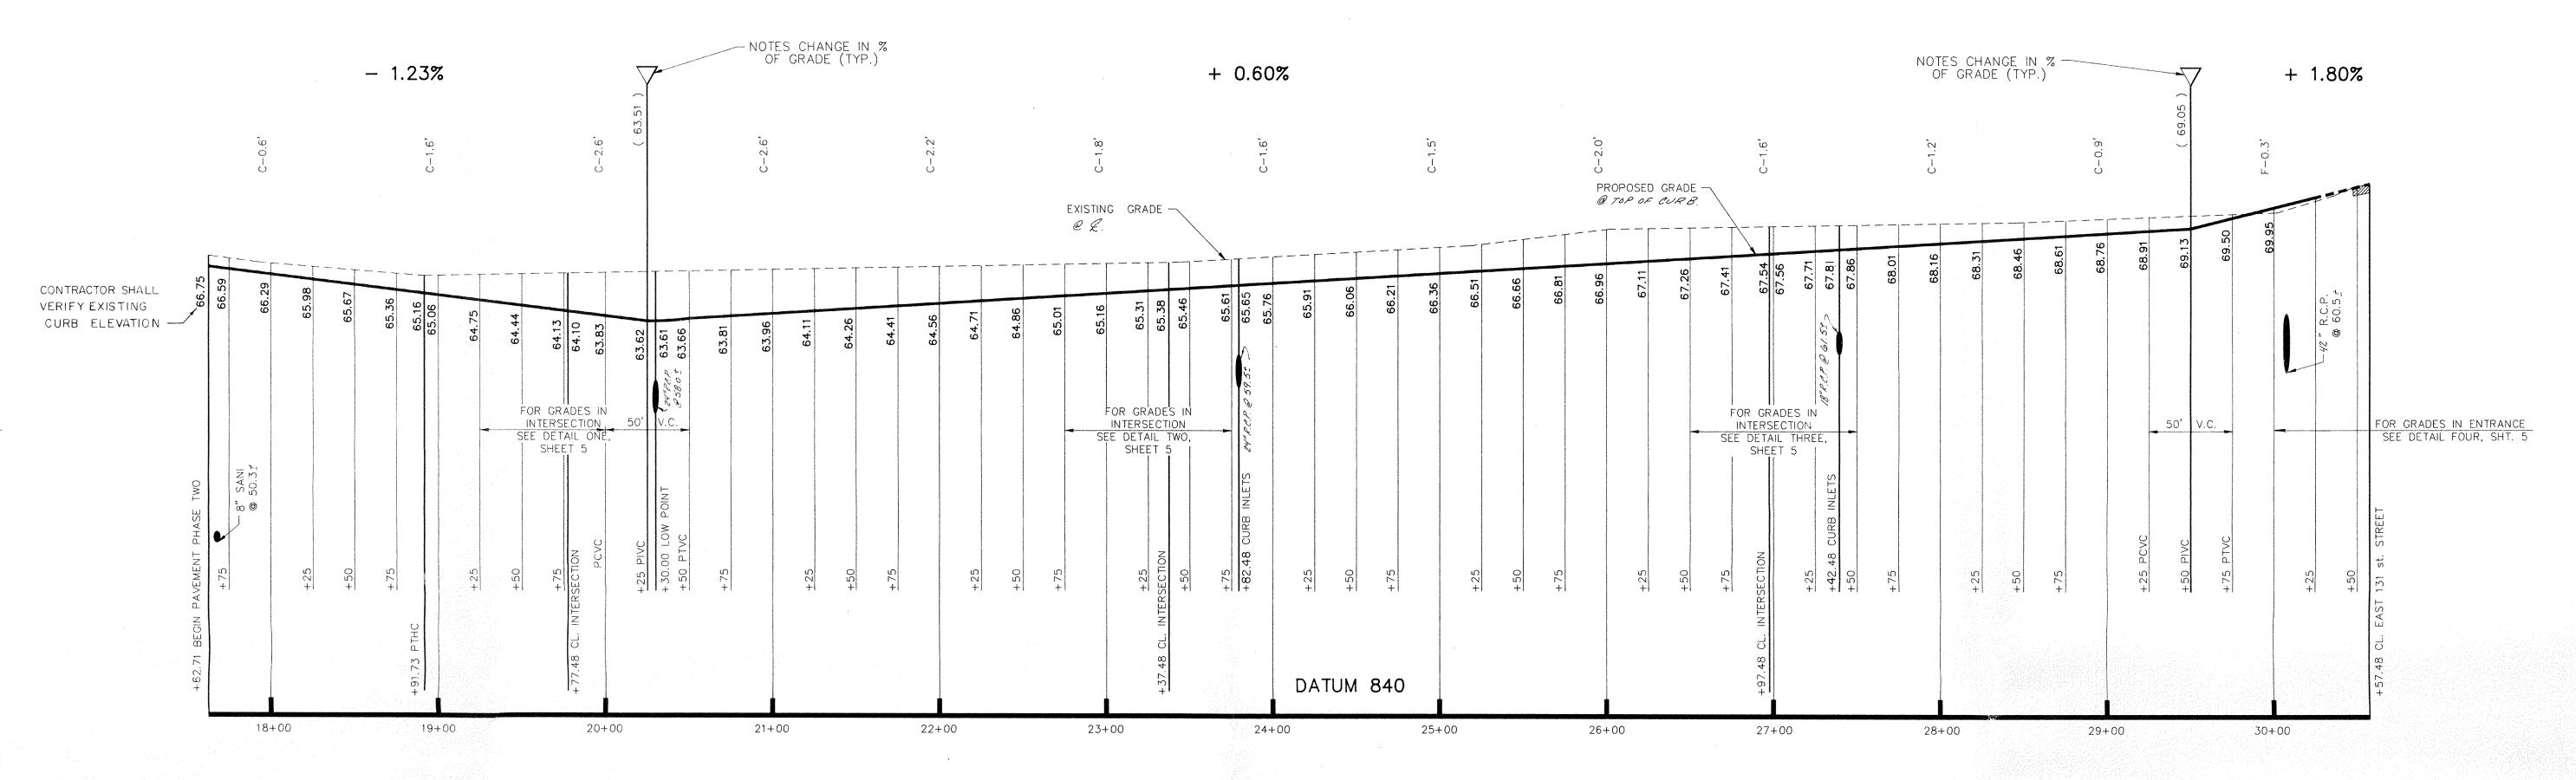
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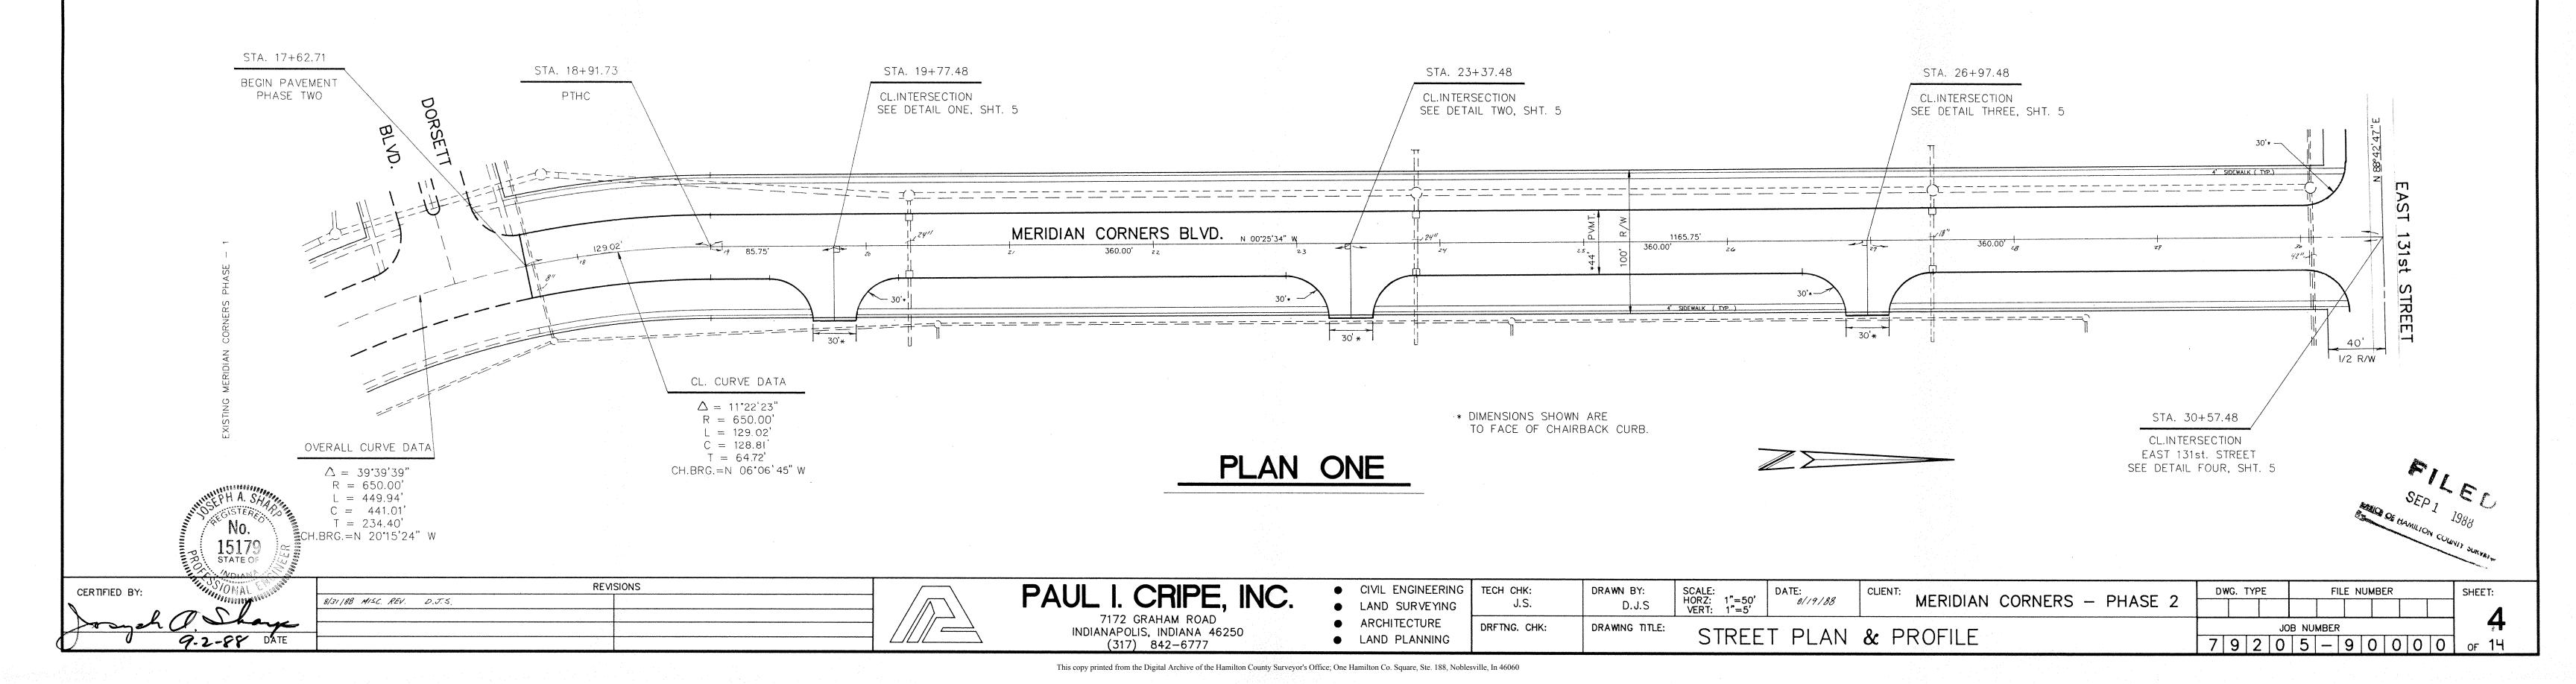
MERIDIAN CORNERS


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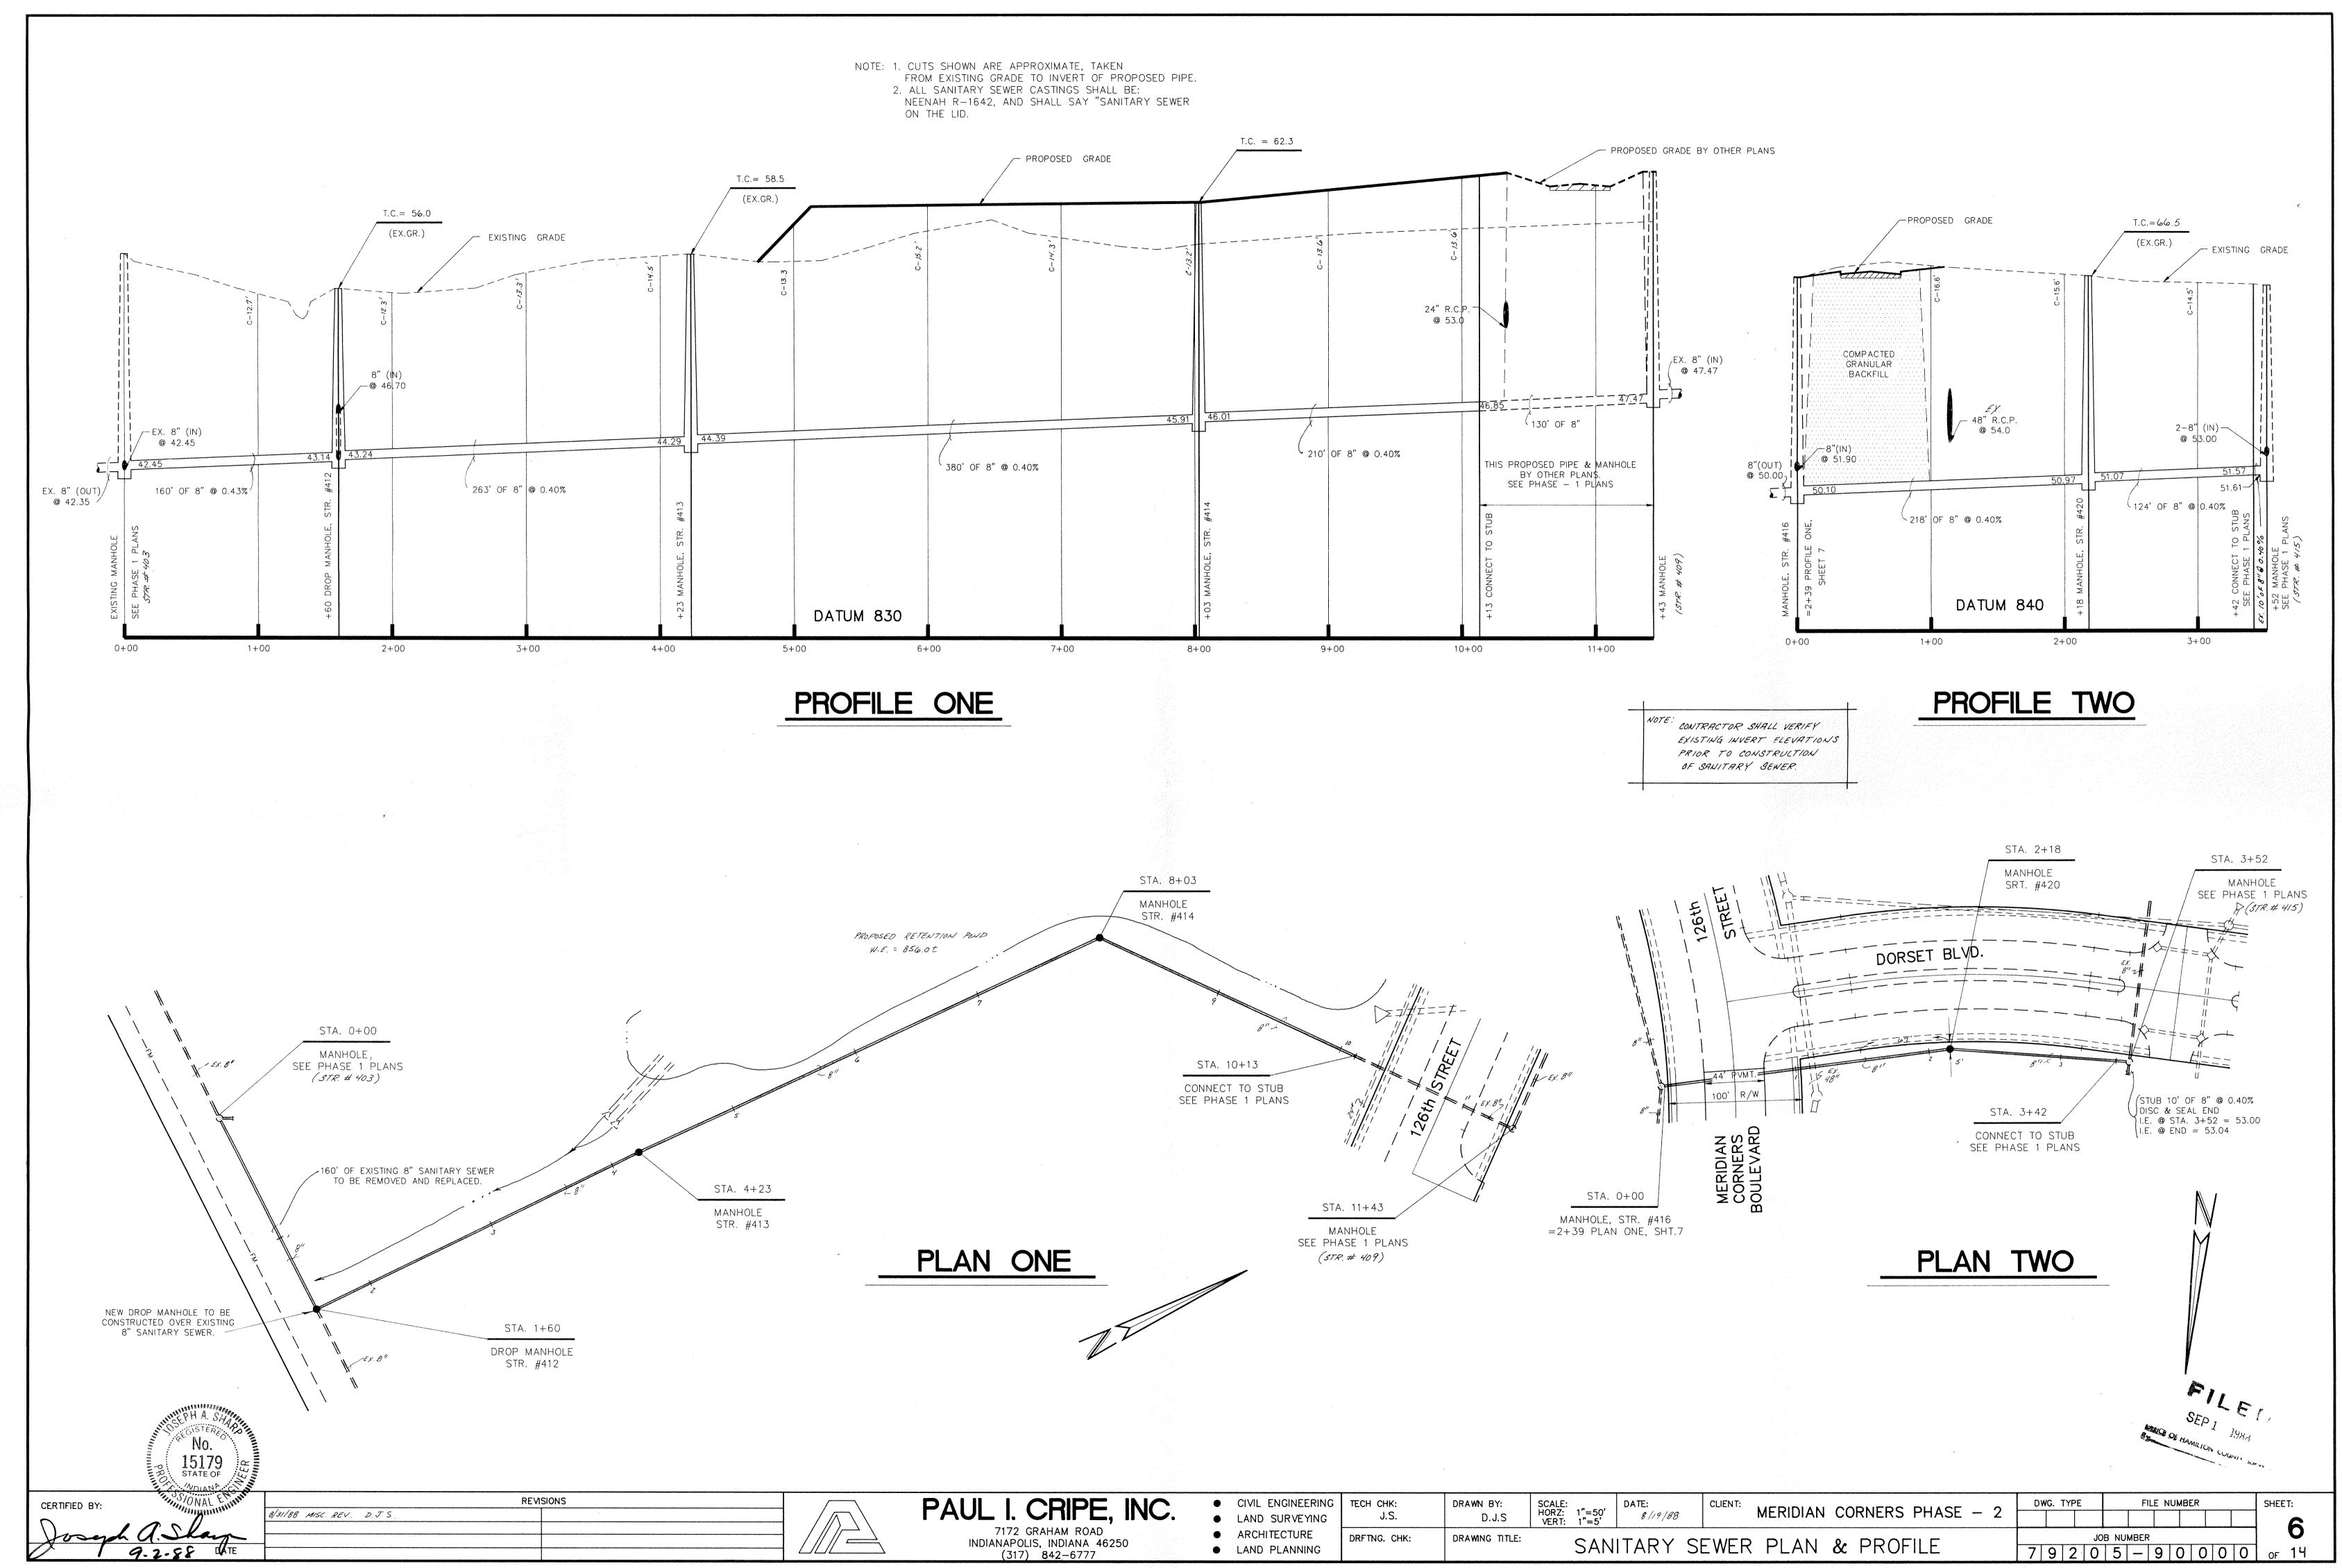













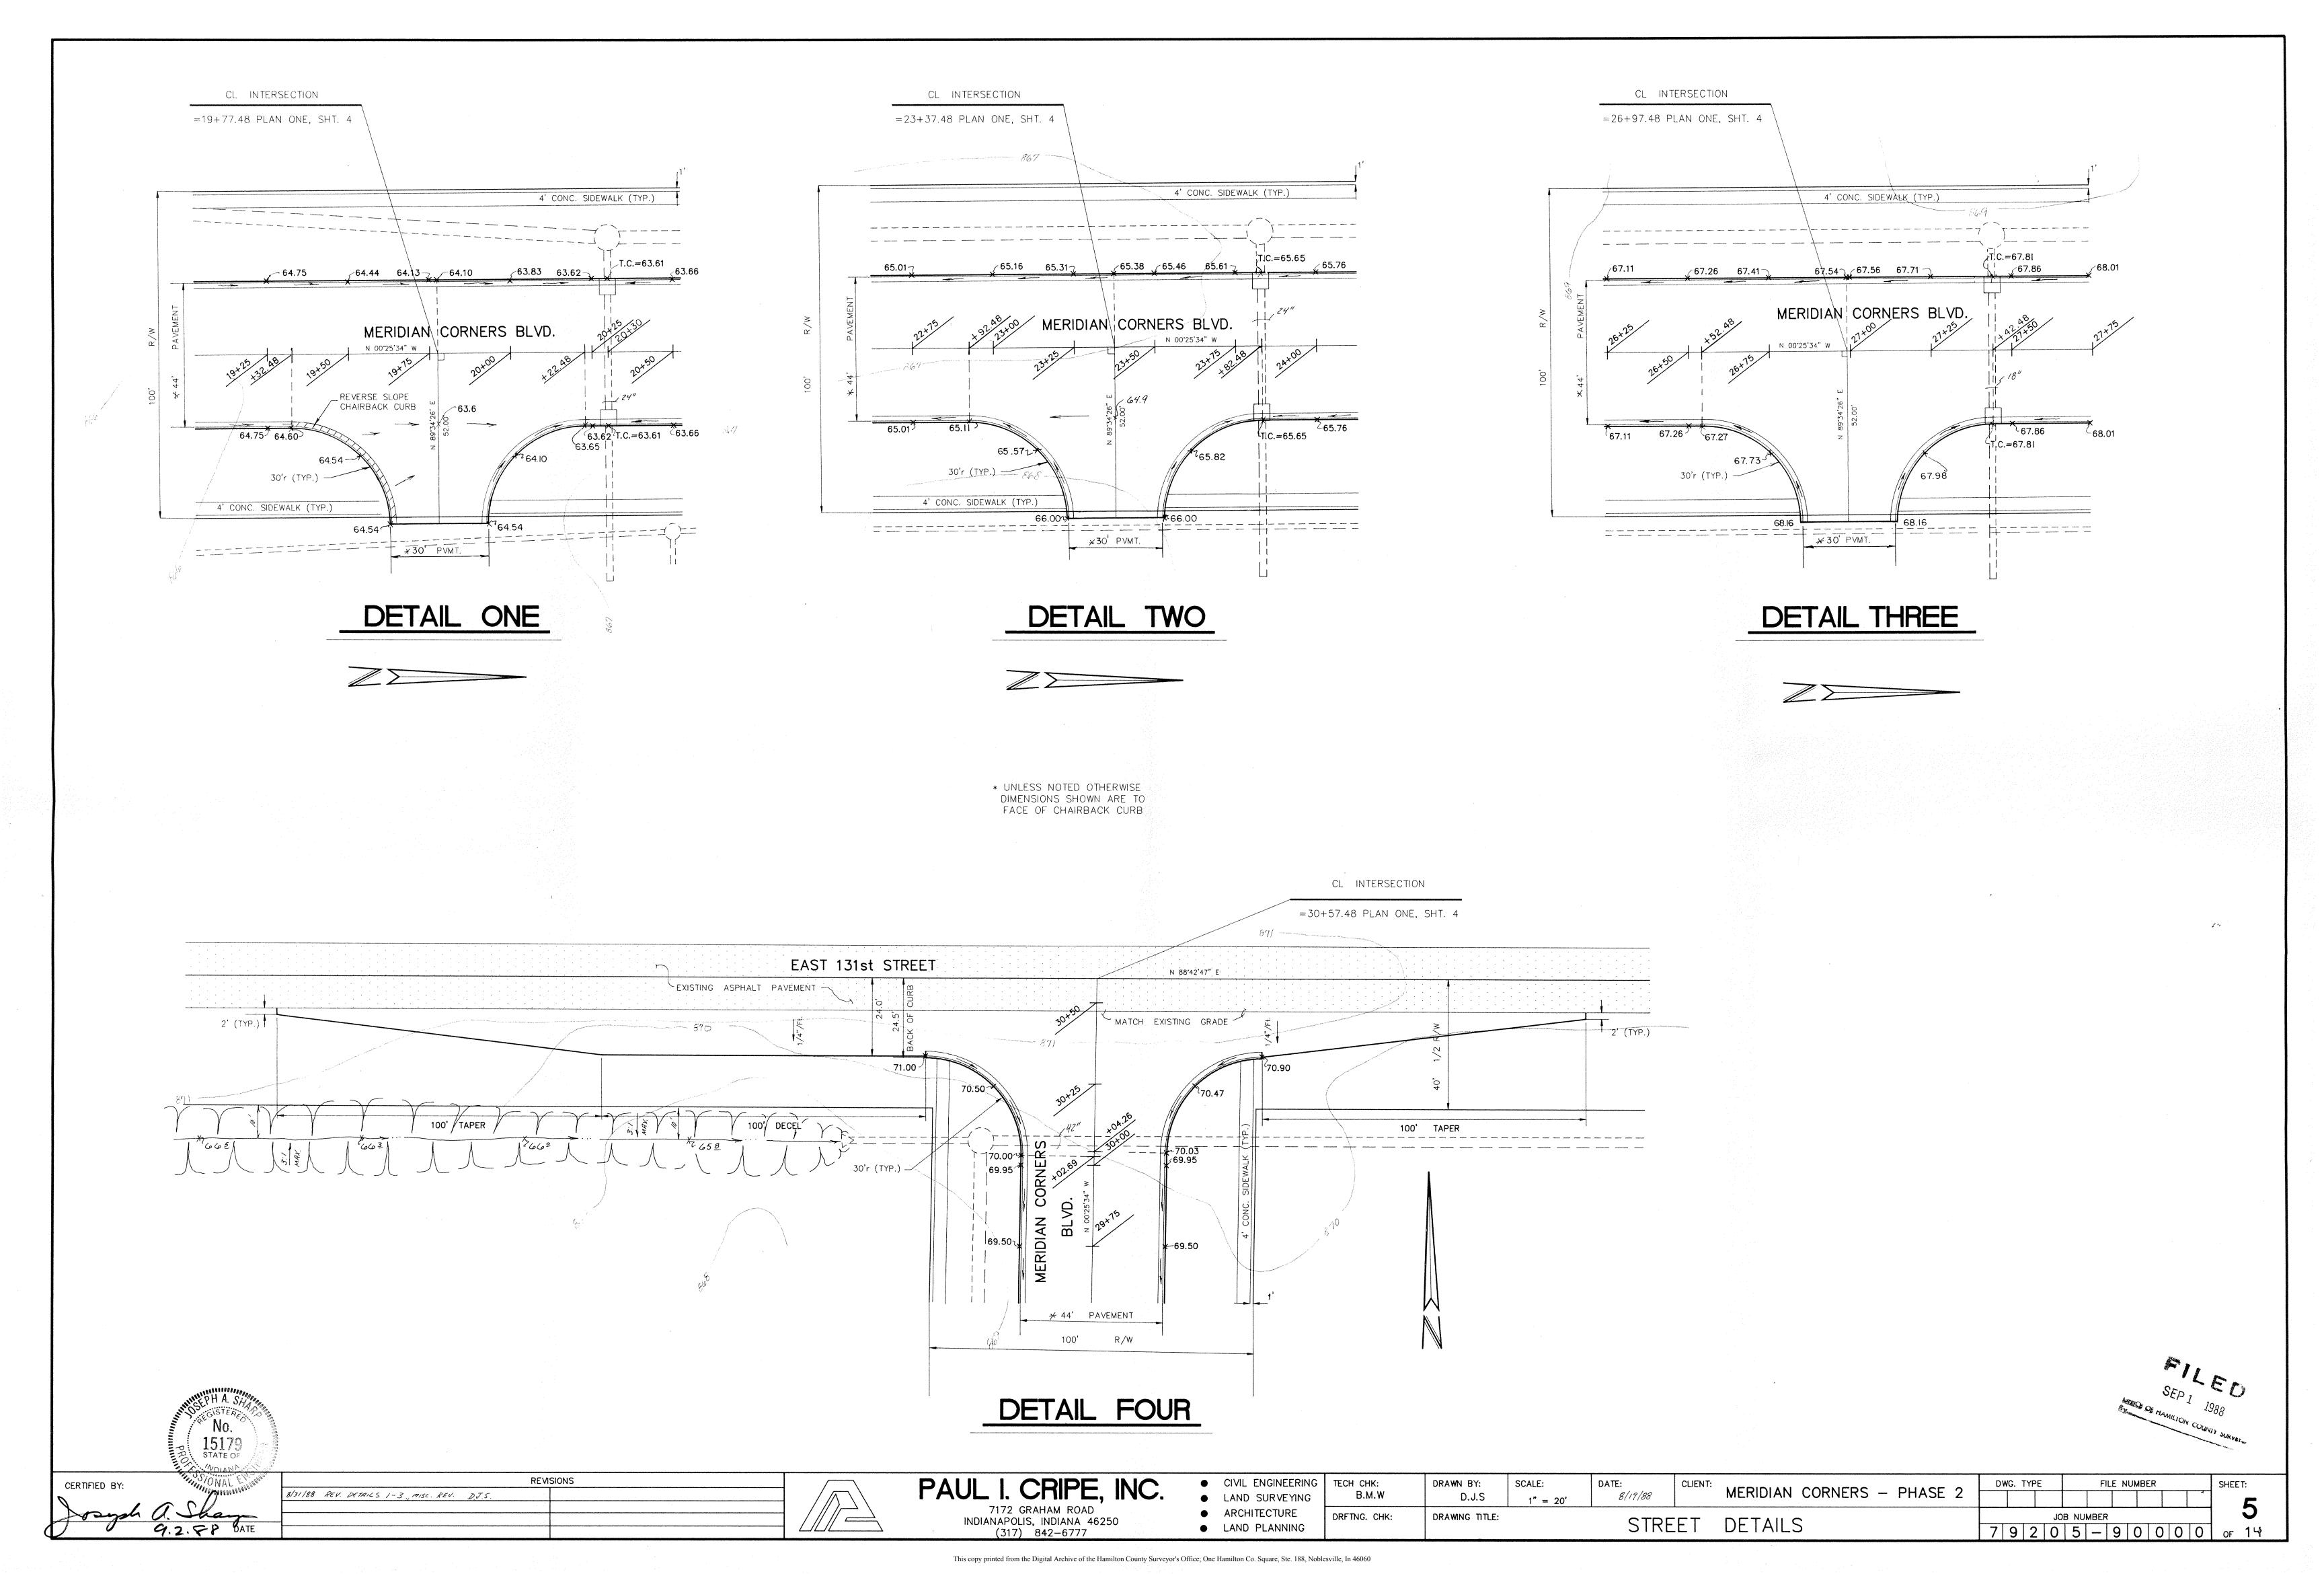

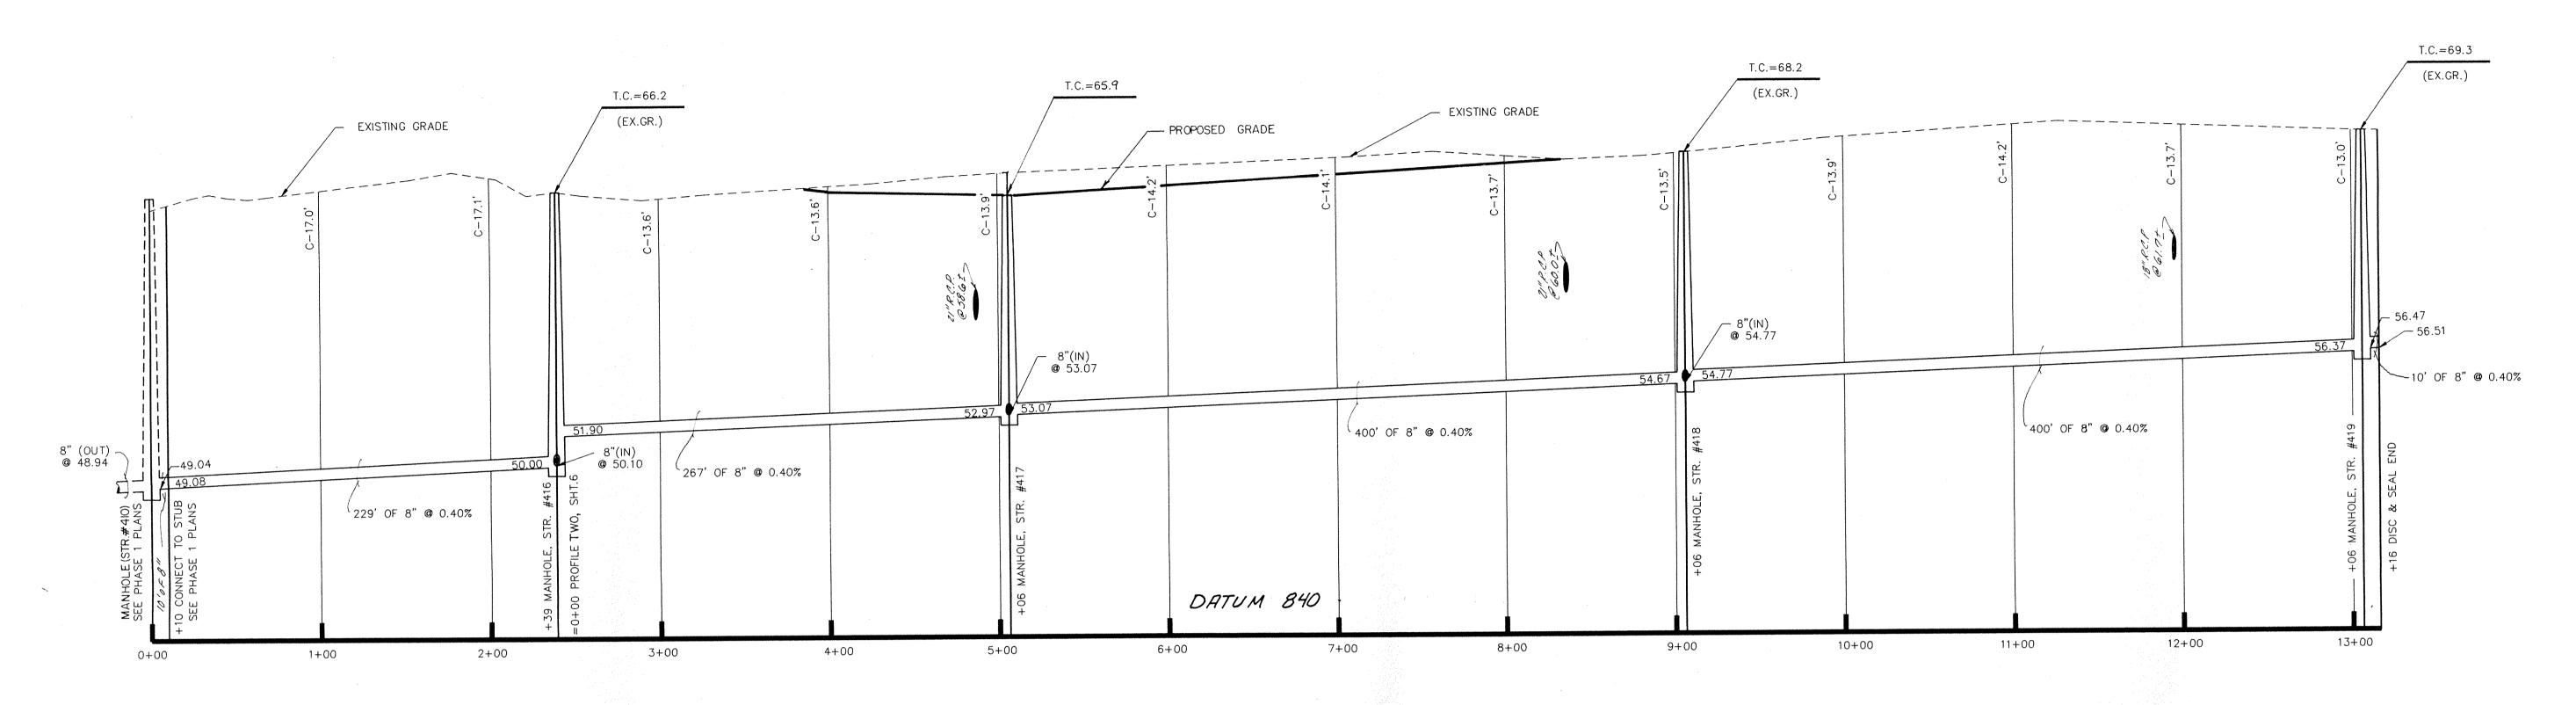

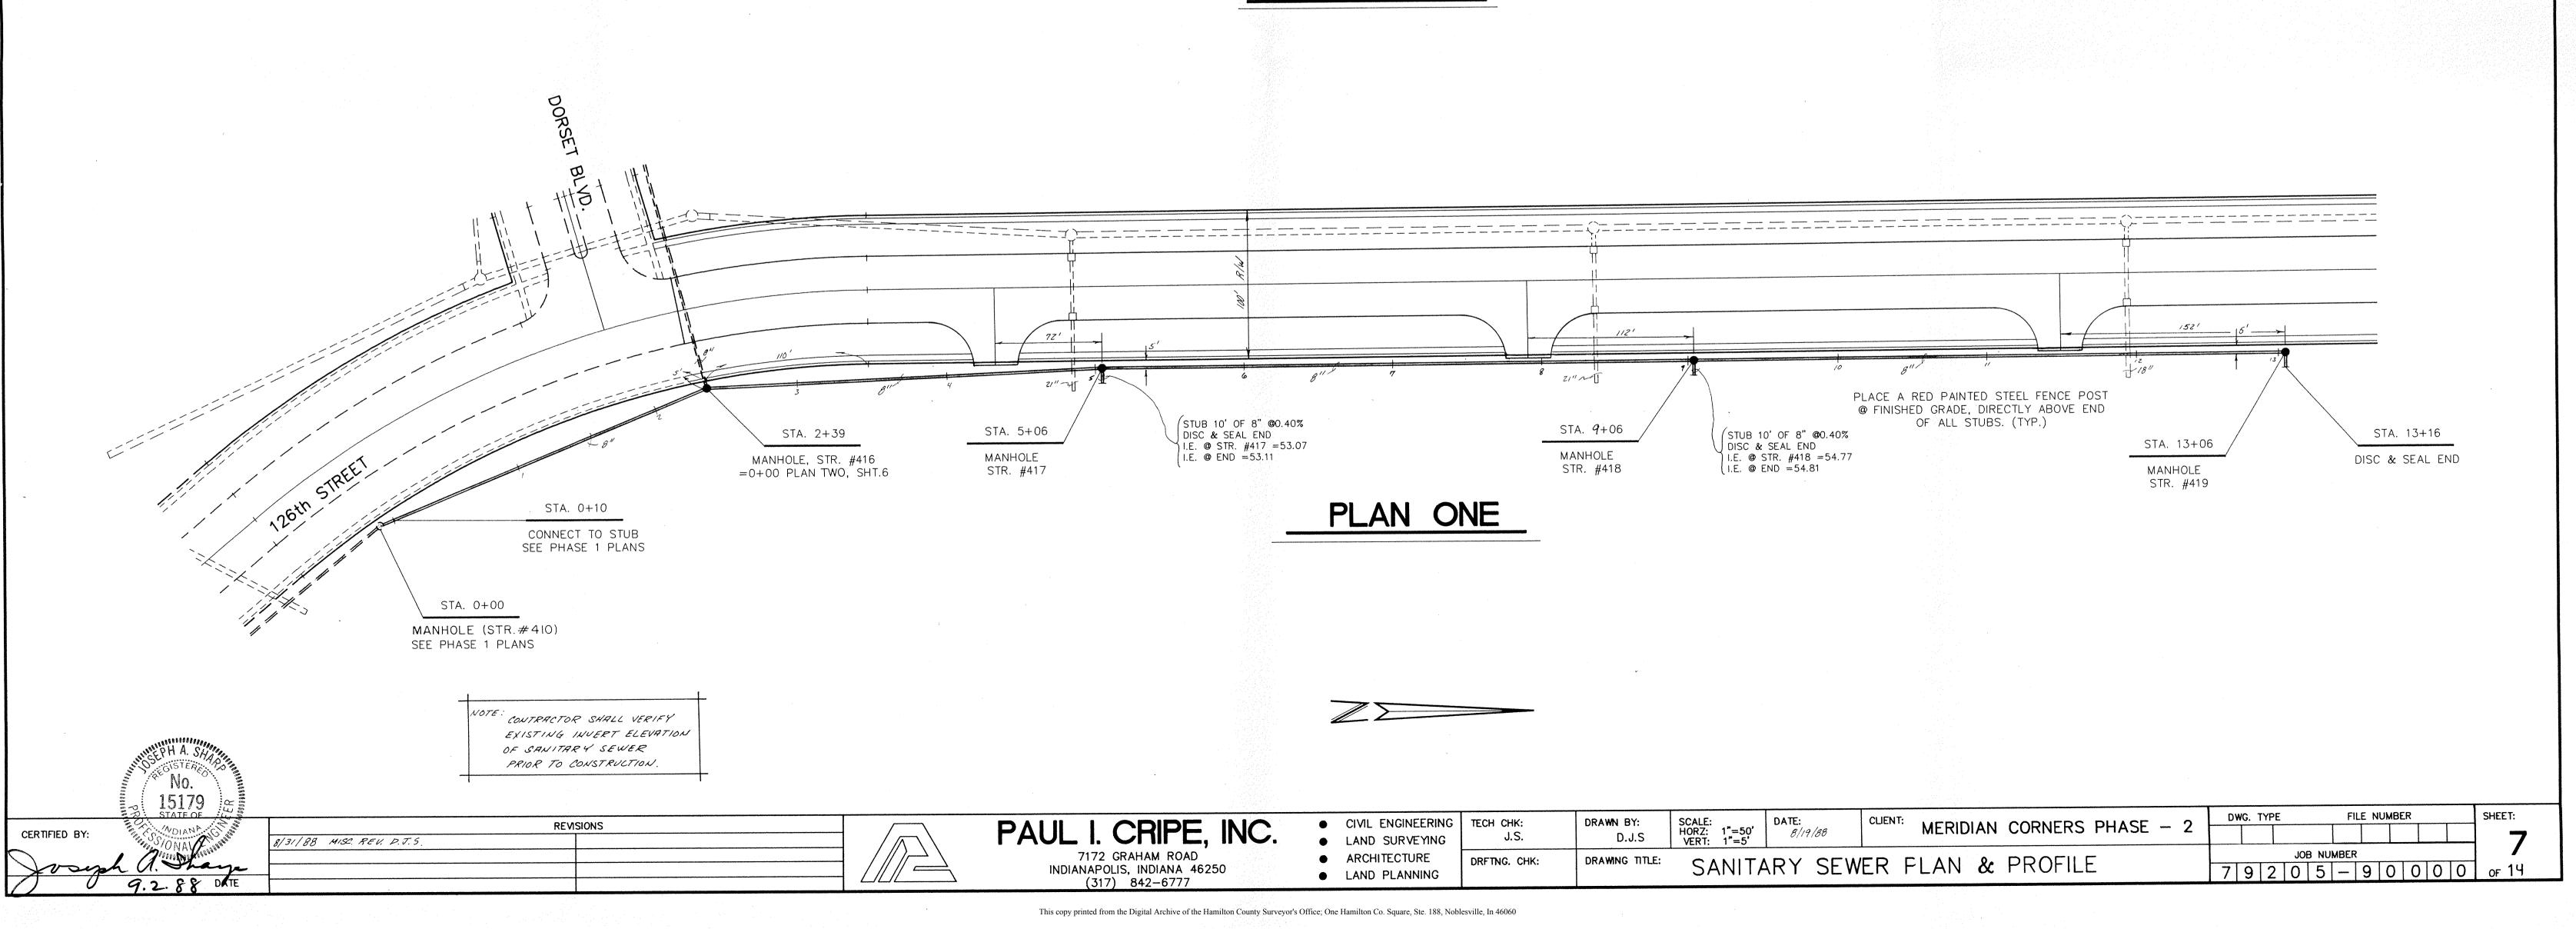

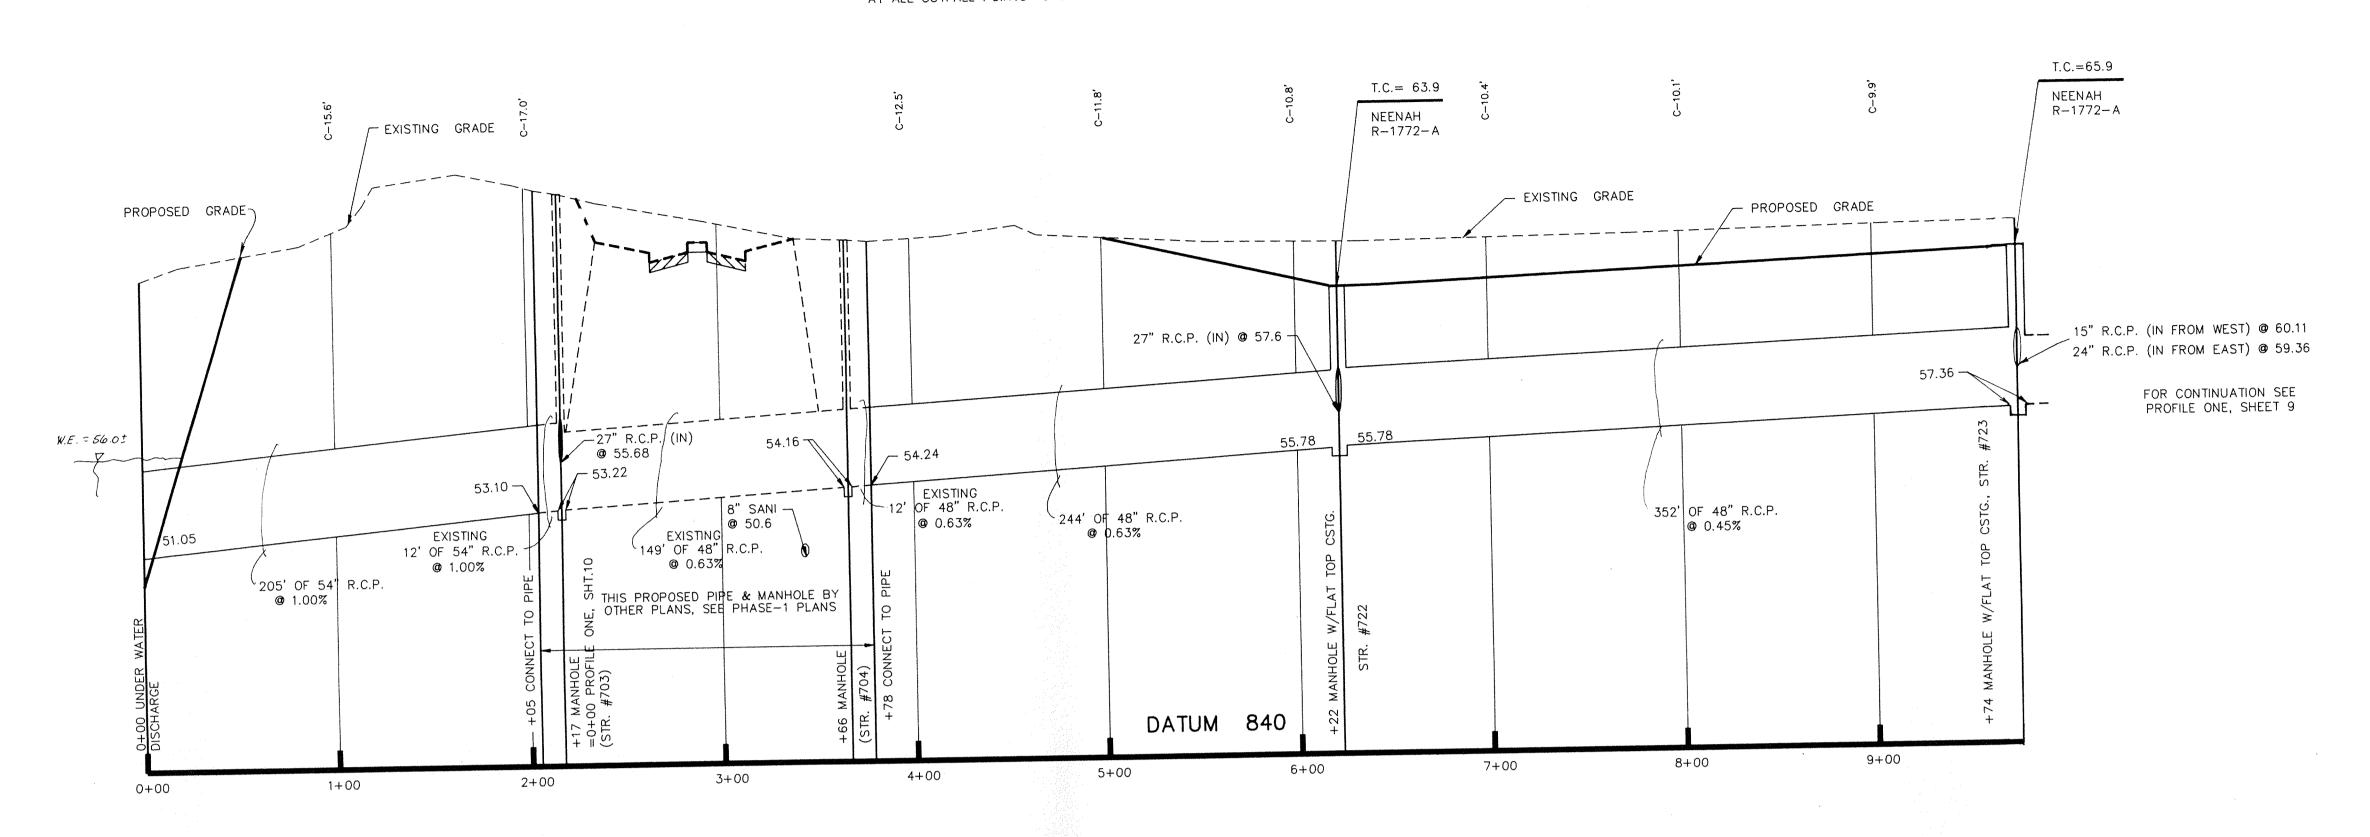

* DIMENSIONS SHOWN ARE TO FACE OF CHAIRBACK CURB. STA. 3+66 30' OF 15" R.C.P. @ 0.50% DISC & SEAL END (NO PROFILE SHOWN)
I.E. @ STR. #723 = 860.11
I.E. @ END = 860.26 MANHOLE, (STR. #704) STA. 9+74 STA. 6+22 STA. 3+78 MANHOLE W/FLAT MANHOLE W/FLAT TOP CSTG. CONNECT TO PIPE TOP CSTG. STR. #722 STR. #723 STA. 2+17 SEE PHASE 1 PLANS MANHOLE, (STR. #703) SEE NOTE: 7~ =0+00 PLAN ONE, SHT. 10 SEE NOTE: 4 STR. #730 SEE NOTE: 1 STA. 2+05 FOR CONTINUATION SEE PLAN ONE, SHEET 9 SEE NOTE: 5 % MERIDIAN CORNERS BLVD. INLET W/CURB CSTG. CONNECT TO PIPE T.C. = 65.65SEE PHASE 1 PLANS NEENAH R-3010 SEE NOTE: 2 STA. 0+00 UNDER WATER SEE NOTE: 3 DISCHARGE STR. #729 INLET W/CURB CSTG. INLET W/CURB CSTG. PROPOSED INLET W/CURB CSTG. T.C. = 63.61NOTE: 4

13' OF 24" R.C.P. @ 0.55%

(NO PROFILE SHOWN)

1.E. @ STR. #723 = 859.36 T.C. = 65.65RETENTION T.C. = 63.61NEENAH R-3010 NEENAH R-3010 POND NEENAH R-3010 I.E. @ STR. #730 = 859.43 COMPACTED GRANULAR BACKFILL PLAN ONE 13' OF 27"R.C.P. @ 0.40% NOTE: 5 45' OF 24" R.C.P. @ 0.40% 48' OF 21" R.C.P. @ 0.40% (NO PROFILE SHOWN) DISC & SEAL END (NO PROFILE SHOWN) I.E. @ STR. #731 = 859.86 I.E. @ STR. #722 = 857.60 (NO PROFILE SHOWN) I.E. @ STR. #728 = 857.65 I.E. \odot STR. #730 = 859.43COMPACTED GRANULAR BACKFILL I.E. @ STR. #731 = 859.61 COMPACTED GRANULAR BACKFILL I.E. @ END = 860.05 CONTRACTOR SHALL PLACE A 48' OF 21" R.C.P. @ 0.60% 45' OF 24" R.C.P. @ 0.50% GREEN PAINTED STEEL FENCE DISC & SEAL END (NO PROFILE SHOWN) POST @ FINISHED GRADE DIRECTLY (NO PROFILE SHOWN) I.E. @ STR. #728 = 857.90 OVER ENDS OF ALL STORM SEWERS. (TYP.) i.E. @ STR. #729 = 858.38 I.E. @ STR. #729 = 858.13 I.E. @ END = 858.67 COMPACTED GRANULAR BACKFILL CLIENT: MERIDIAN CORNERS - PHASE 2 CIVIL ENGINEERING | TECH CHK: SCALE: HORZ: 1"=50' VERT: 1"=5' PAUL I. CRIPE, INC. DRAWN BY:

7172 GRAHAM ROAD

INDIANAPOLIS, INDIANA 46250 (317) 842-6777

LAND SURVEYING

ARCHITECTURE

LAND PLANNING

REVISIONS

8/3//88 REV. PIPE LENGTH PLAN & PROFILE, MISC. REV. D.T.S.

CERTIFIED BY:

D.J.S

DRAWNG TITLE:

DRFTNG. CHK:


STORM SEWER PLAN & PROFILE

SHEET:


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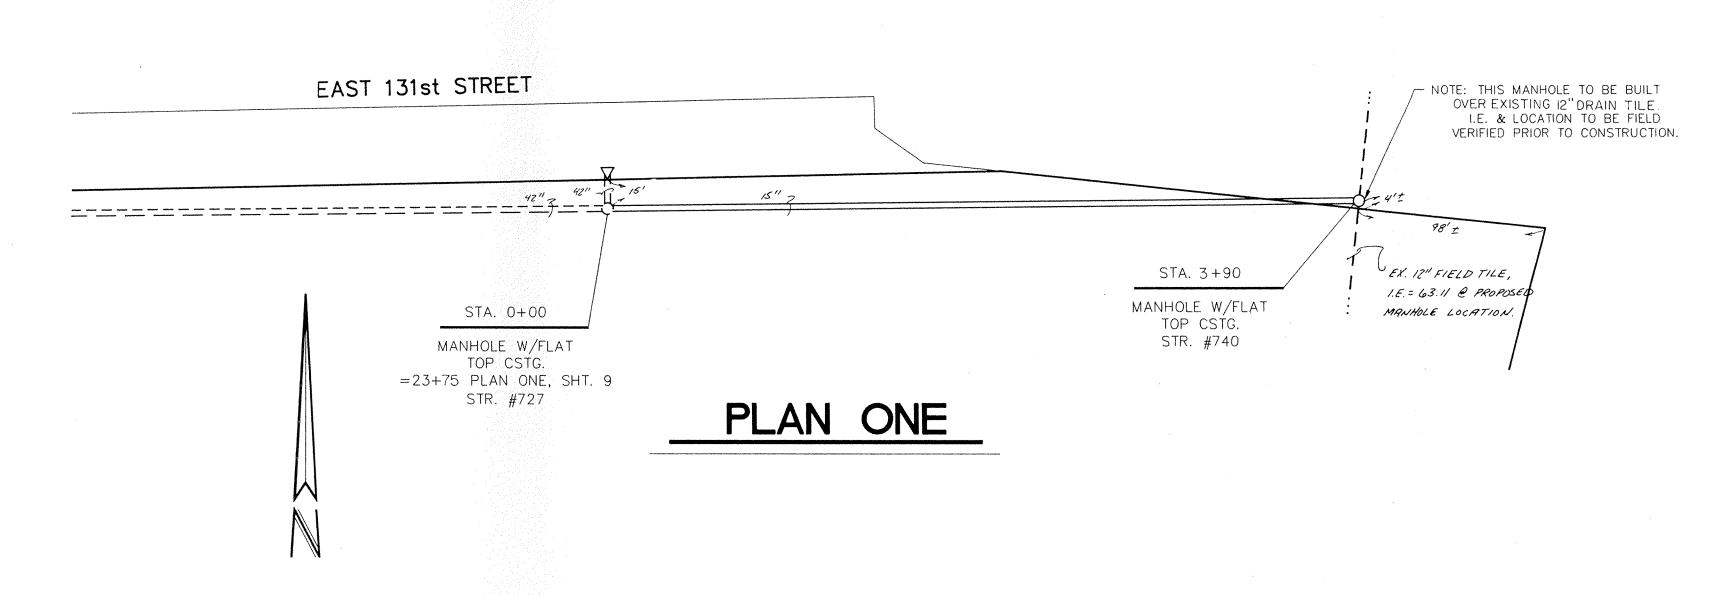
JOB NUMBER



NOTE: CUTS SHOWN ARE APPROXIMATE, TAKEN FROM EXISTING GRADE TO INV. OF PROPOSED PIPE. FIELD ADJUSTMENT BY ENGINEER MAY BE REQUIRED AT ALL OUTFALL POINTS TO INSURE PROPER OUTFALL CONDITIONS.

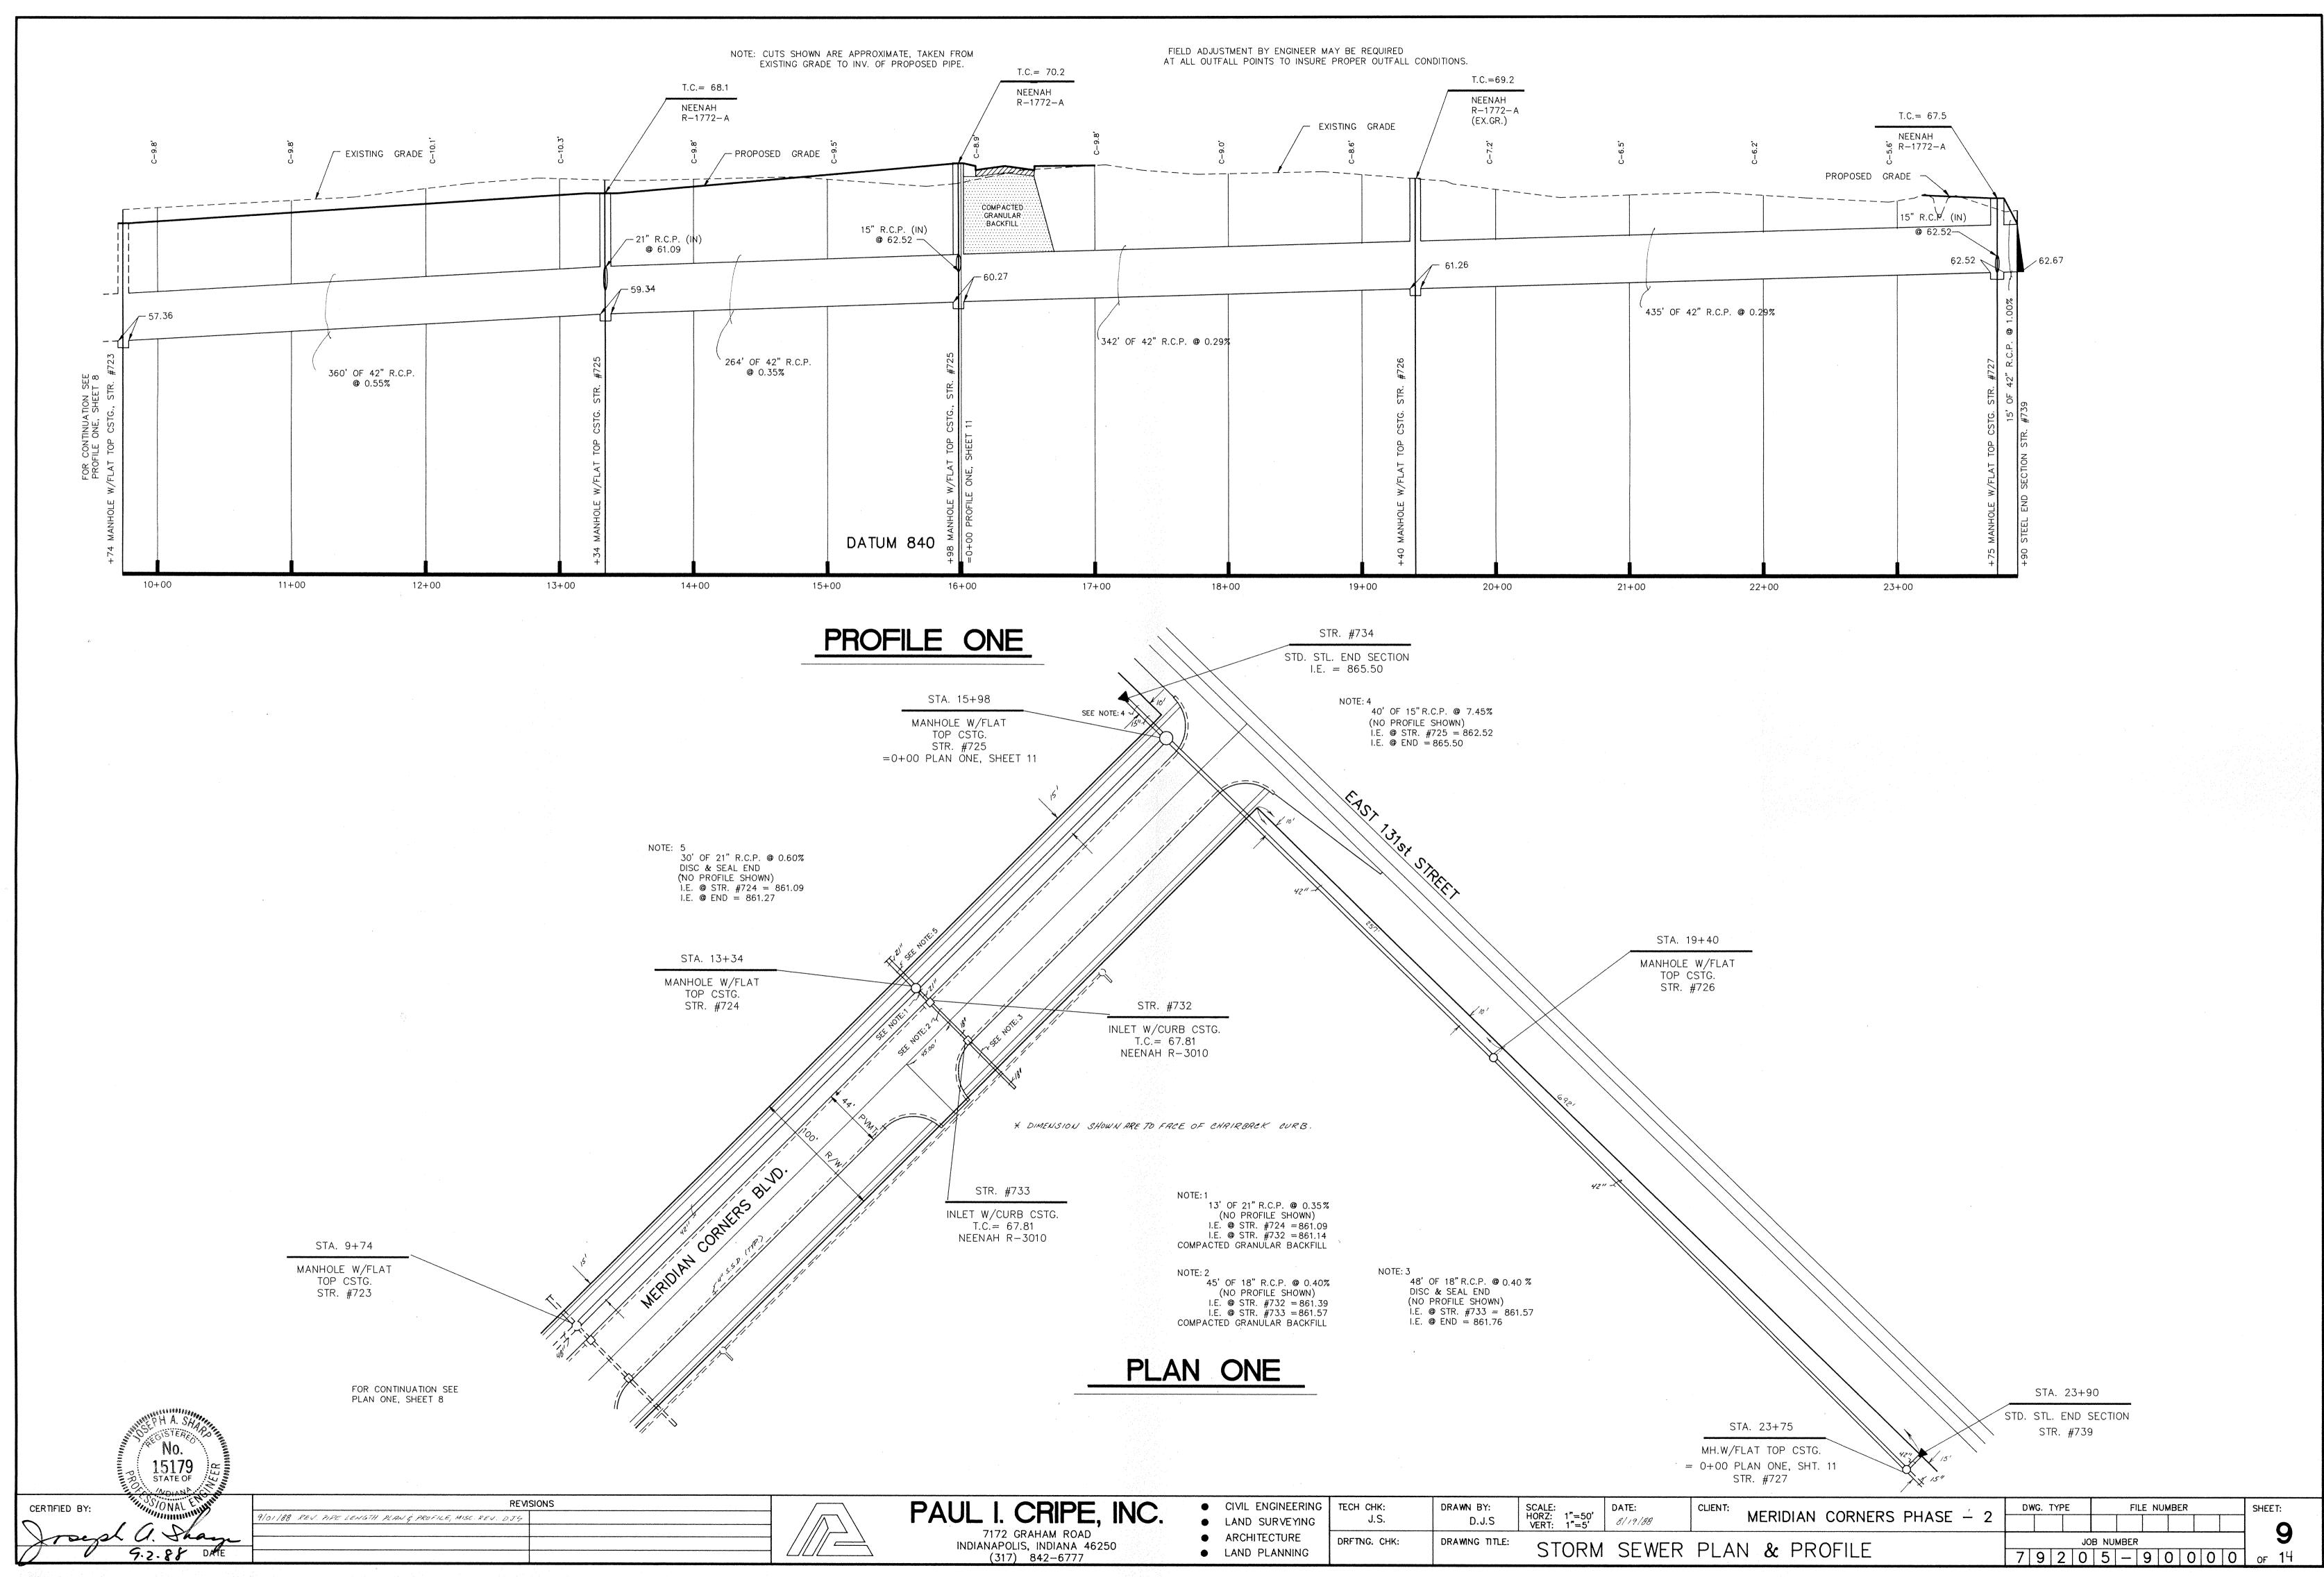

PROFILE ONE

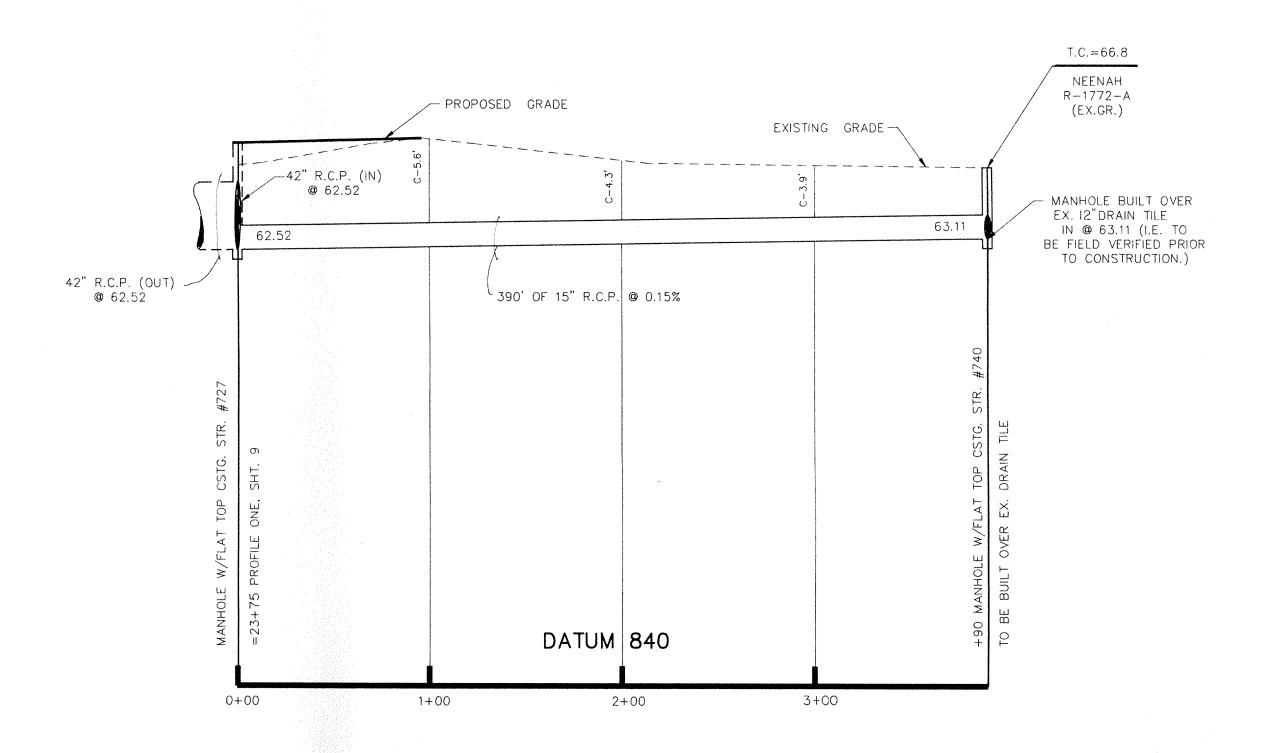

SHEET:

No. 15179 STATE OF CERTIFIED BY:

1/01/88 MISC. REV. D.J.S.

REVISIONS

PAUL I. CRIPE, INC.
7172 GRAHAM ROAD
INDIANAPOLIS, INDIANA 46250
(317) 842-6777


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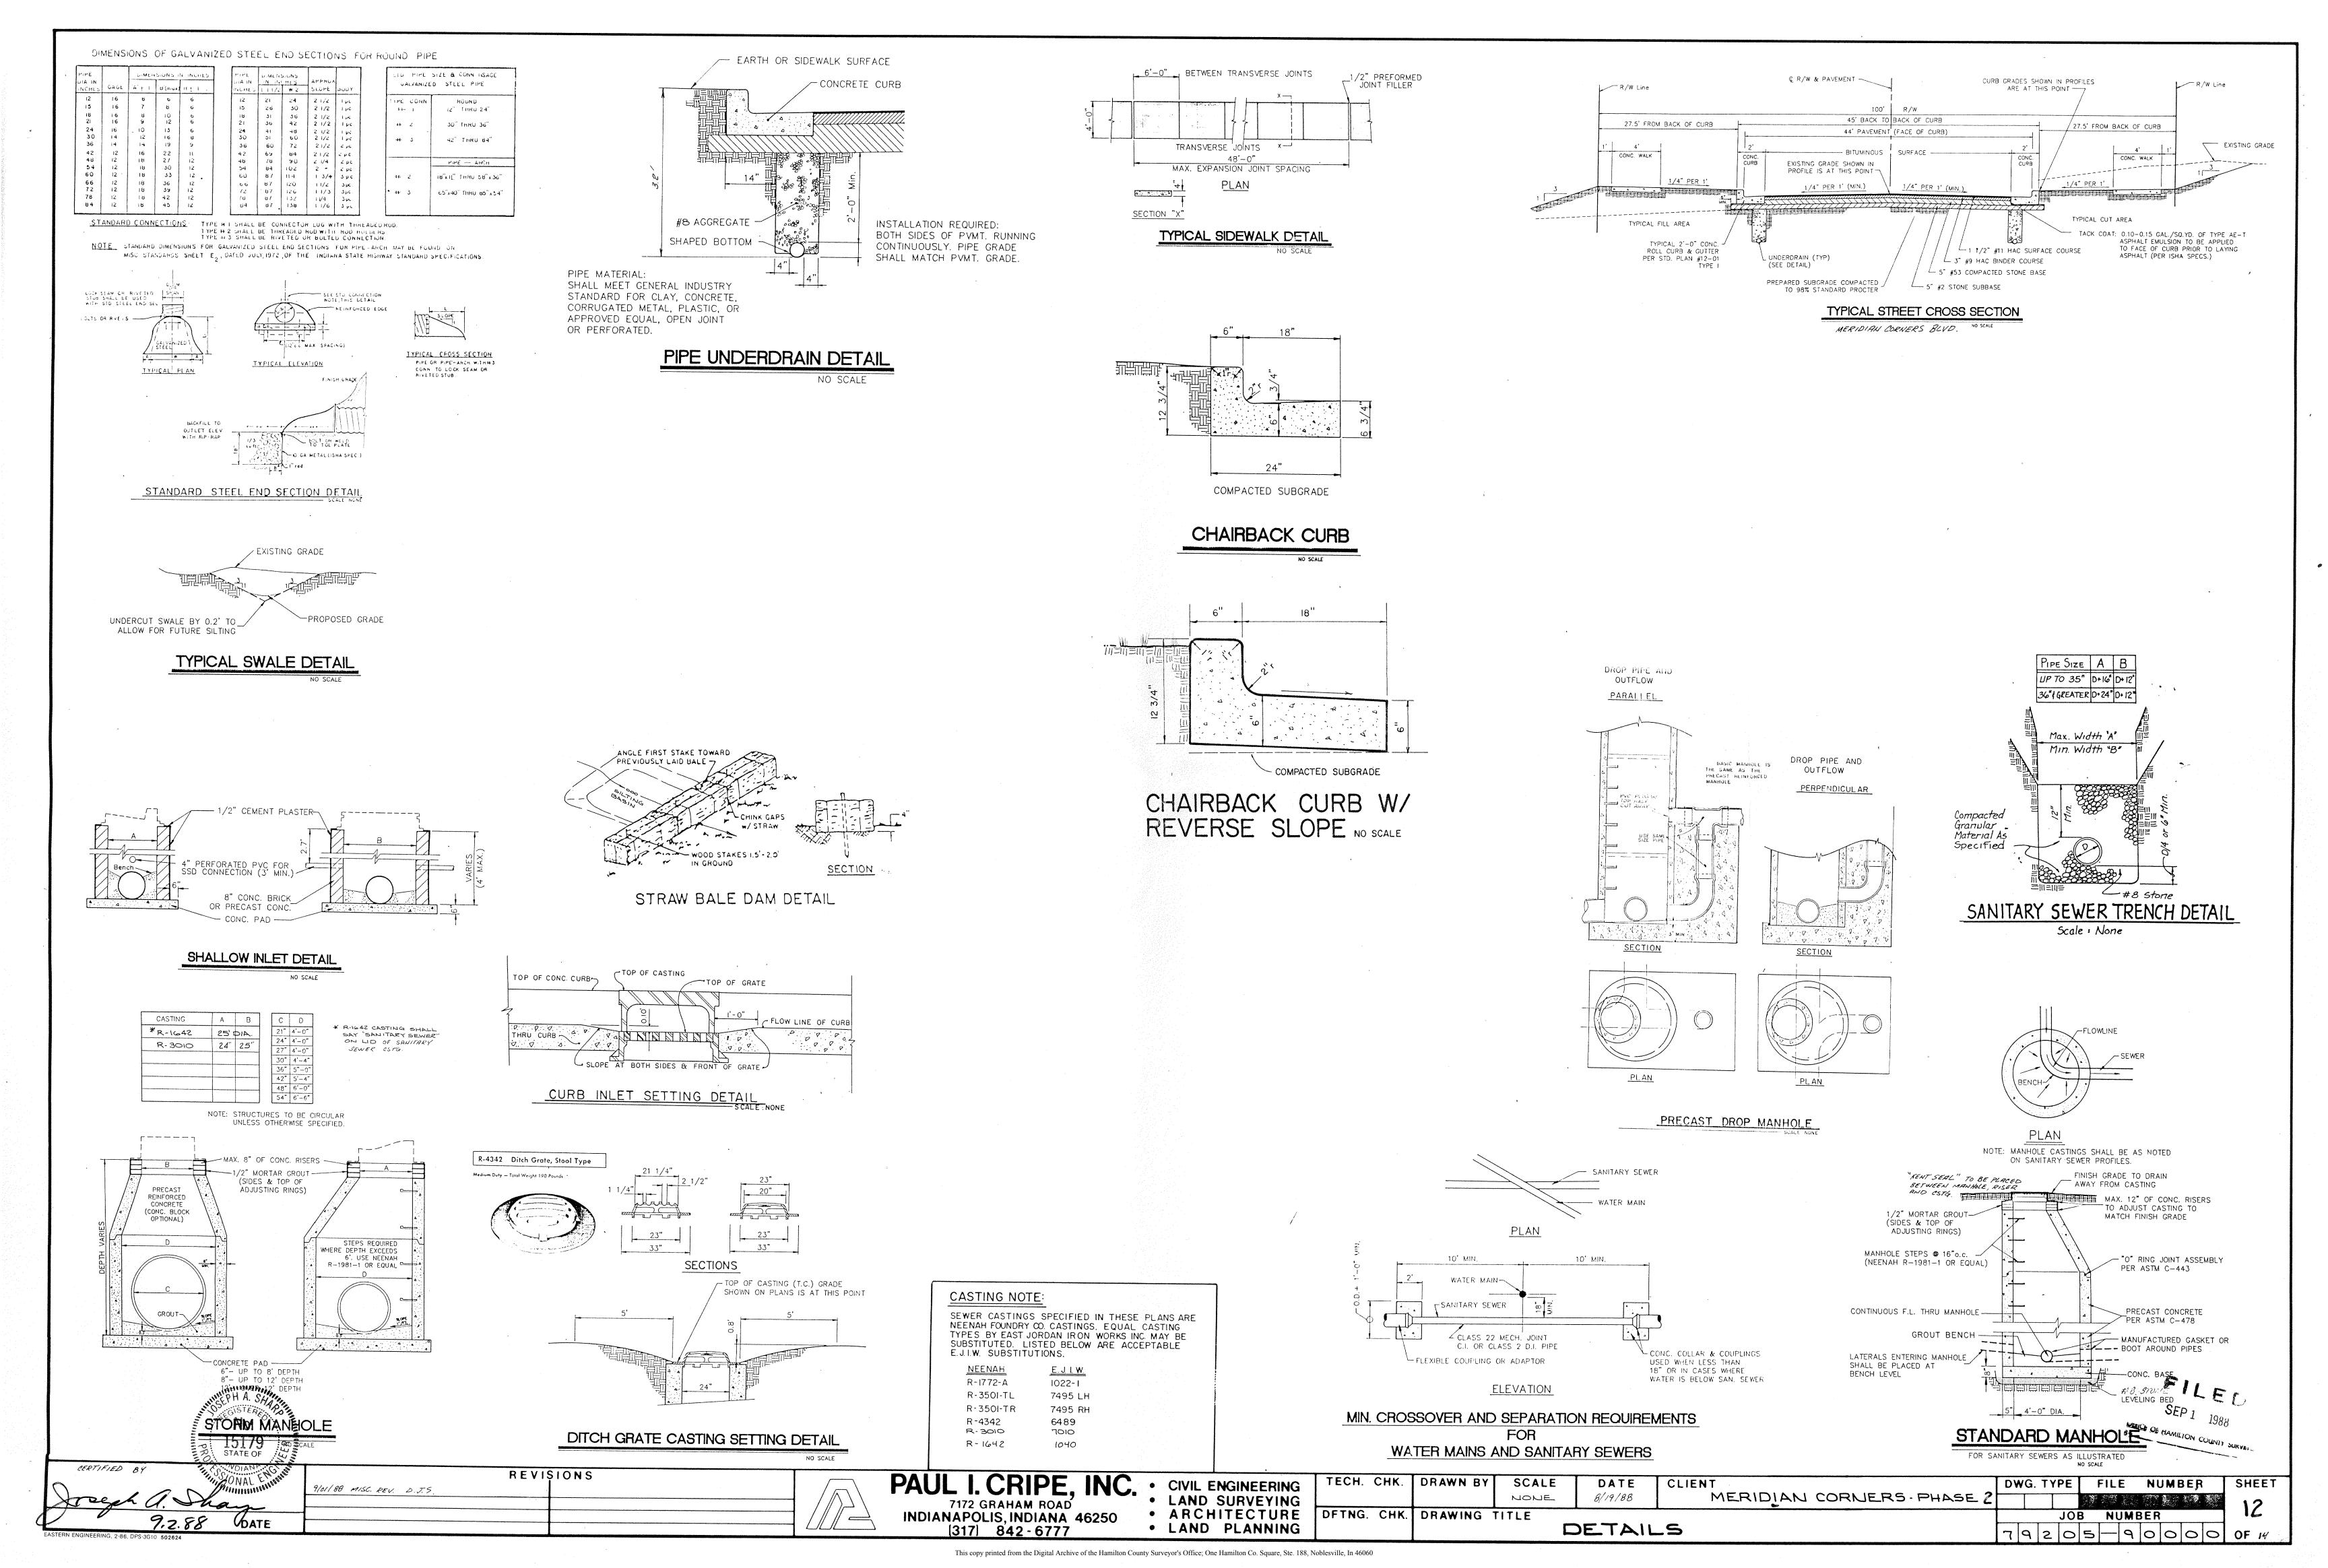
SCALE: HORZ: 1"=50' VERT: 1"=5' DRAWN BY: D.J.S DRAWING TITLE:

MERIDIAN CORNERS - PHASE 2 STORM SEWER PLAN & PROFILE

FILE NUMBER DWG. TYPE JOB NUMBER 7 9 2 0 5 - 9 0 0 0 0 of 14

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SPECIFICATIONS

The standard specifications for the City of Carmel shall apply for all work and materials.

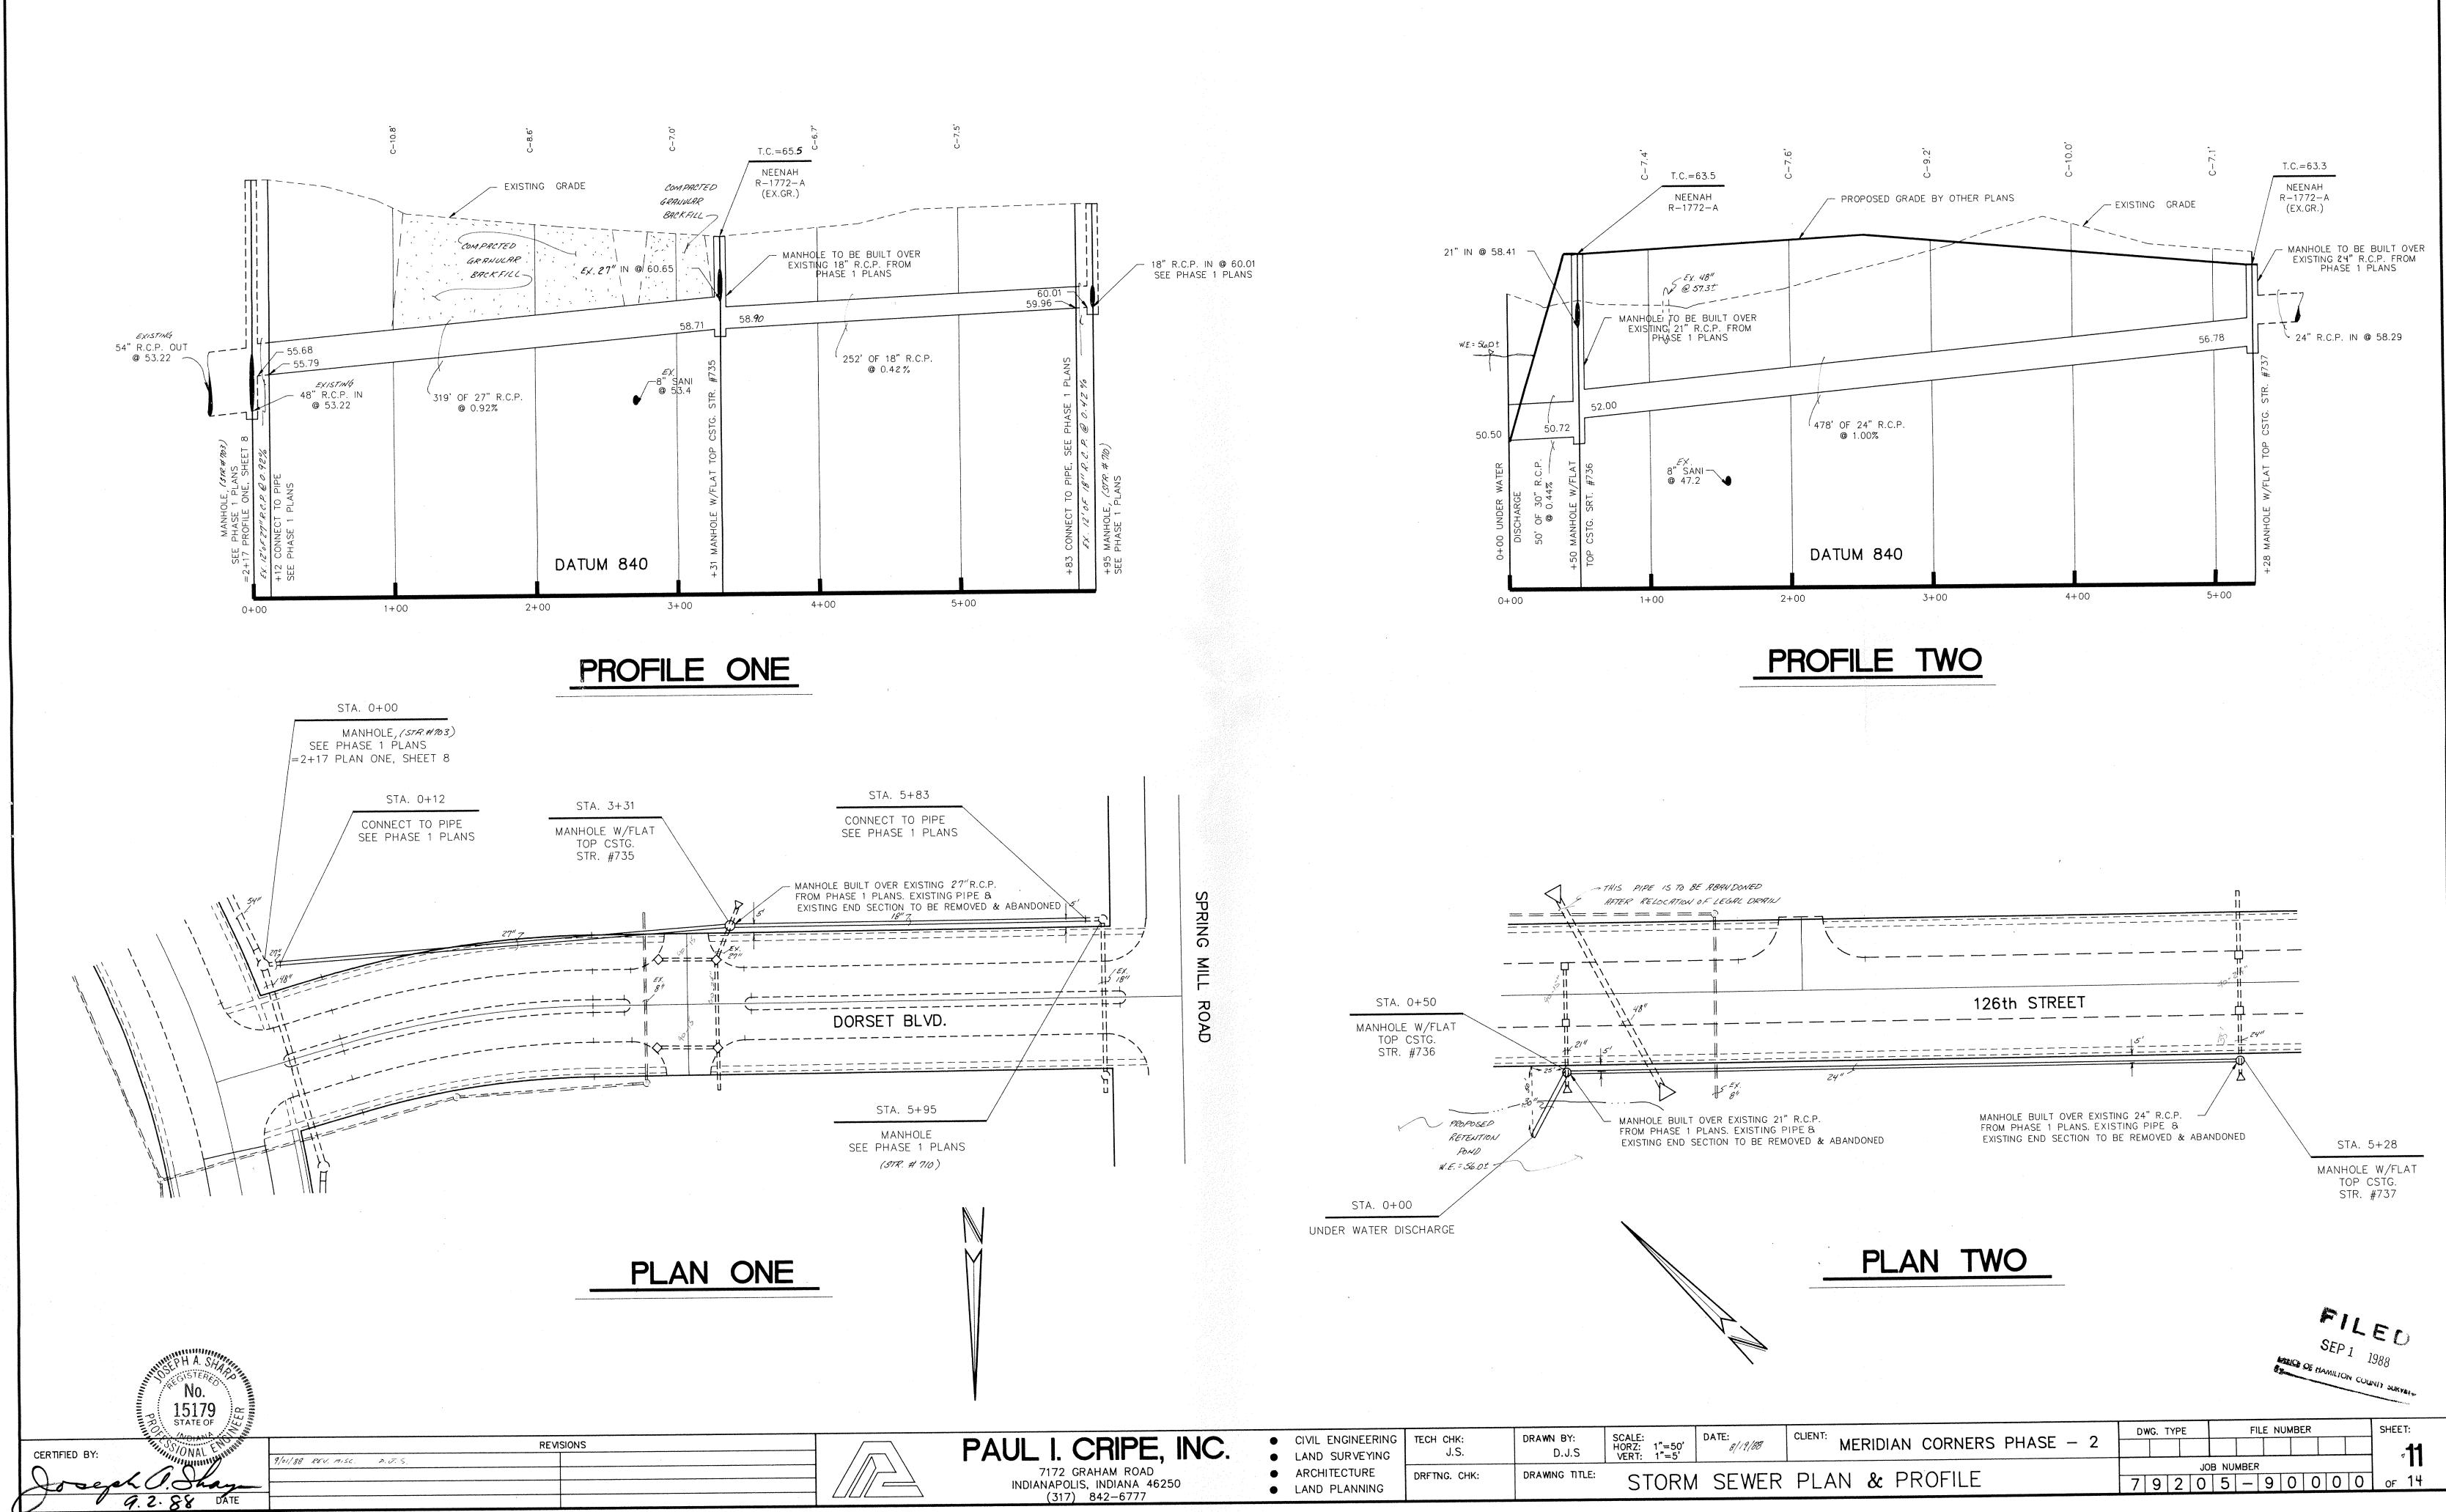STORM

- 1. Storm sewer pipes shall be reinforced concrete (R.C.P.) in accordance with ASTM-C-76, or corrugated metal pipe (CMP) one size larger in accordance with AASH spec. M-36.
- 2. Exceptional areas may require additional subsurface drainage. Street and storm sewer contractors shall include in their bids a unit cost per foot of installation of 4" dia. perforated plastic underdrain (see detail sheet 12). Location of such underdrain will be at the direction of the owner, or the engineer.
- 3. Rip-rap shall be installed at pipe inlets or outlets as the owner/engineer directs. Contractor shall include unit price for rip-rap, min 1/3 c.f. rock size, installed.
- 4. Storm sewer discharge areas and inverts are tentative and are subject to field modifications according to the unit prices submitted by the Contractor on the contract documents.
- 5. The Contractor shall provide at least 21 of cover over all storm sewers.
- 6. All drainage pipe and ditch outfalls to receiving streams shall be constructed in accordance with drawings, subject however, to any modification required by City of Carmel at the time installation is completed and to any adjustments needed for field conditions not adequately anticipated by the design drawings.
- 7. Casting Elevations are set by plan. However, the casting elevations are to be adjusted in the field by the Engineer's representative should a discrepancy occur between plan grade and existing grade.
- 8. All structures and all cuts under proposed paved areas shall be backfilled with granular material in addition to areas specifically noted on the plans. The granular material shall completely fill the trench in the area under the proposed pavement and shall extend at a one-to-one slope from the proposed pavement edge.
- 9. The Contractor shall contact all utility companies before any construction is started. He shall obtain the exact location of any utility lines and shall protect these lines during construction.
- 10. The Contractor shall be responsible for obtaining all State, Highway, City and County permits.
- 11. The Contractor shall be required to furnish the Engineer with a set of prints, marked in red, showing actual sewer location and invert, to include lateral location, depth and length. Such "as built" prints must be received by the Engineer before the final contract payment can be authorized.
- 12. The Contractor will be reimbursed for any additional labor and/or materials arising from the changes other than minor adjustments to manholes authorized by the Engineer. Reimbursement will be in accordance with unit prices submitted by the Contractor on the contract documents.

Sanitary Sewer Specifications

- 1. Standard specifications of the Indiana State Board of Health shall
- apply for all work and materials. 2. All sanitary sewer in this project shall be Polyvinyl Chloride (PVC) meeting requirements set forth in ASTM D-3034 (SDR 35) Pipe shall have a groove and gasket connection. All joints and fitting shall conform to the same standards as the pipe.
- 3. Bedding for flexible pipe shall conform to Clay Township Regional Waste District Specifications.
- 4. Backfill around all structures and all cuts under paved area with granular material. Mechanically compact all granular fill to same percentage as street subgrade.
- 5. The Contractor shall be responsible for obtaining all State, City and County permits.
- 6. Alignment and grade changes in plan may be deviated from in field with Engineer's approval. Final plans furnished with maintenance
- bond and completed affidavit shall reflect "as built" conditions. 7. All sewer shall be Air Tested per State Board of Health requirements. All "flexible" pipe shall have an approved "Mandrel" pulled thru each length. If infiltration is evident, a Weir Test shall be performed also. All tests shall be certified.
- 8. Construction of sidewalks near sewer trenches shall be delayed until six months after completion of sewer, or the sewers shall be backfilled with granular material.
- 9. Leveling material under base of manholes shall be #8 stone.

Soil Erosion Control Summary

The following is a list in sequence of construction activities to control soil

- 1. Contractor shall install sediment traps and straw bale filters, as shown.
- 2. grade the site (sides of swales, mounds and ponds to be seeded and mulched immediately upon completion). Temporary seeding shall be recommended for all swales and disturbed areas that cannot be final seeded within a time period that will prevent slope erosion. For temporary seeding the contractor shall utilize a fast growing seed of either oats, annual ryegrass, wheat or rye depending on time of year. Disturbed areas should be kept to a minimum at all times.
- 3. Contractor shall control mud accumulation on all streets surrounding project by installing stone surface at all locations: where construction traffic leaves the site. Dust shall be kept to a minimum by utilizing sprinkling, Calcium Chloride, Vegetative cover, spray on adhesives or other approved methods.
- 4. Maintain all filters and traps during construction to prevent any blockages from accumulated sediment. Additional seeding and straw bales may be required during construction as specified by Engineer or Soil Conservation Service. Rip rap shall be placed in areas of high velocity stream flow (minimum size 1/3 cu. ft.). Payment for additional straw bales shall be at the Contractors expense. Payment for additional rip rap (not shown on plans) and seeding shall be paid for on a unit basis.
- 5. Contractor shall install all sanitary sewers, storm sewers, subsurface drains, and water mains. Straw bale filters shall be installed at all storm inlets (including street inlets).
- 6. All proposed street areas shall be paved as soon as possible after subgrade is prepared.
- 7. All disturbed areas shall be seeded and mulched as specified below. This shall include all building pad fill areas.
- 8. Contractor shall remove all temporary erosion and sediment controls only when there is a sufficient growth of ground cover to prevent further erosion.

Seeding Specifications:

1. Swales/Grassed Waterways: Permanent seeding shall take place between March 1 and May 15 or from August 10 to October 15 with the following per acre:

> 25# Kentucky 31 Fesque 15# Kentucky Blue Grass 1000# 12-12-12 Fertilizer 3000# Mulch (Straw)

- 2. If grades are established between May 15 and August 10, a temporary seeding consisting of 40# of Annual Ryegrass shall be planted per acre.
- 3. If grades are established between October 15 and December 30, either Rye (grain) or Wheat may be used at the rate of 2 bushels/Ac. Oats may be used for early spring planting at the rate of 3 bushels/Ac. All grains should be cut at time of permanent seeding. All grains should be cut prior to seed maturing.
- 4. If temporary seeding is established prior to permanent seeding, the mulch may be eliminated except in "bare"
- 5. If grading occurs during December, January, or February, no seeding to take place till spring planting time; however, it is imperative that all sediment filters and traps are in place prior to bulk earthmoving or
- 6. All areas along street (approximately 25 foot behind curb) shall be seeded the same as swales.
- 7. All lots where grading has occured, shall be seeded with the temporary seeding process.
- 8. All dates shown are nominal, and may be varied with concurrence of the Engineer or the Local Soil Conservationist.

REVISIONS 9/01/88 MISC. REV. D.J.G.

[317] **842-6777**

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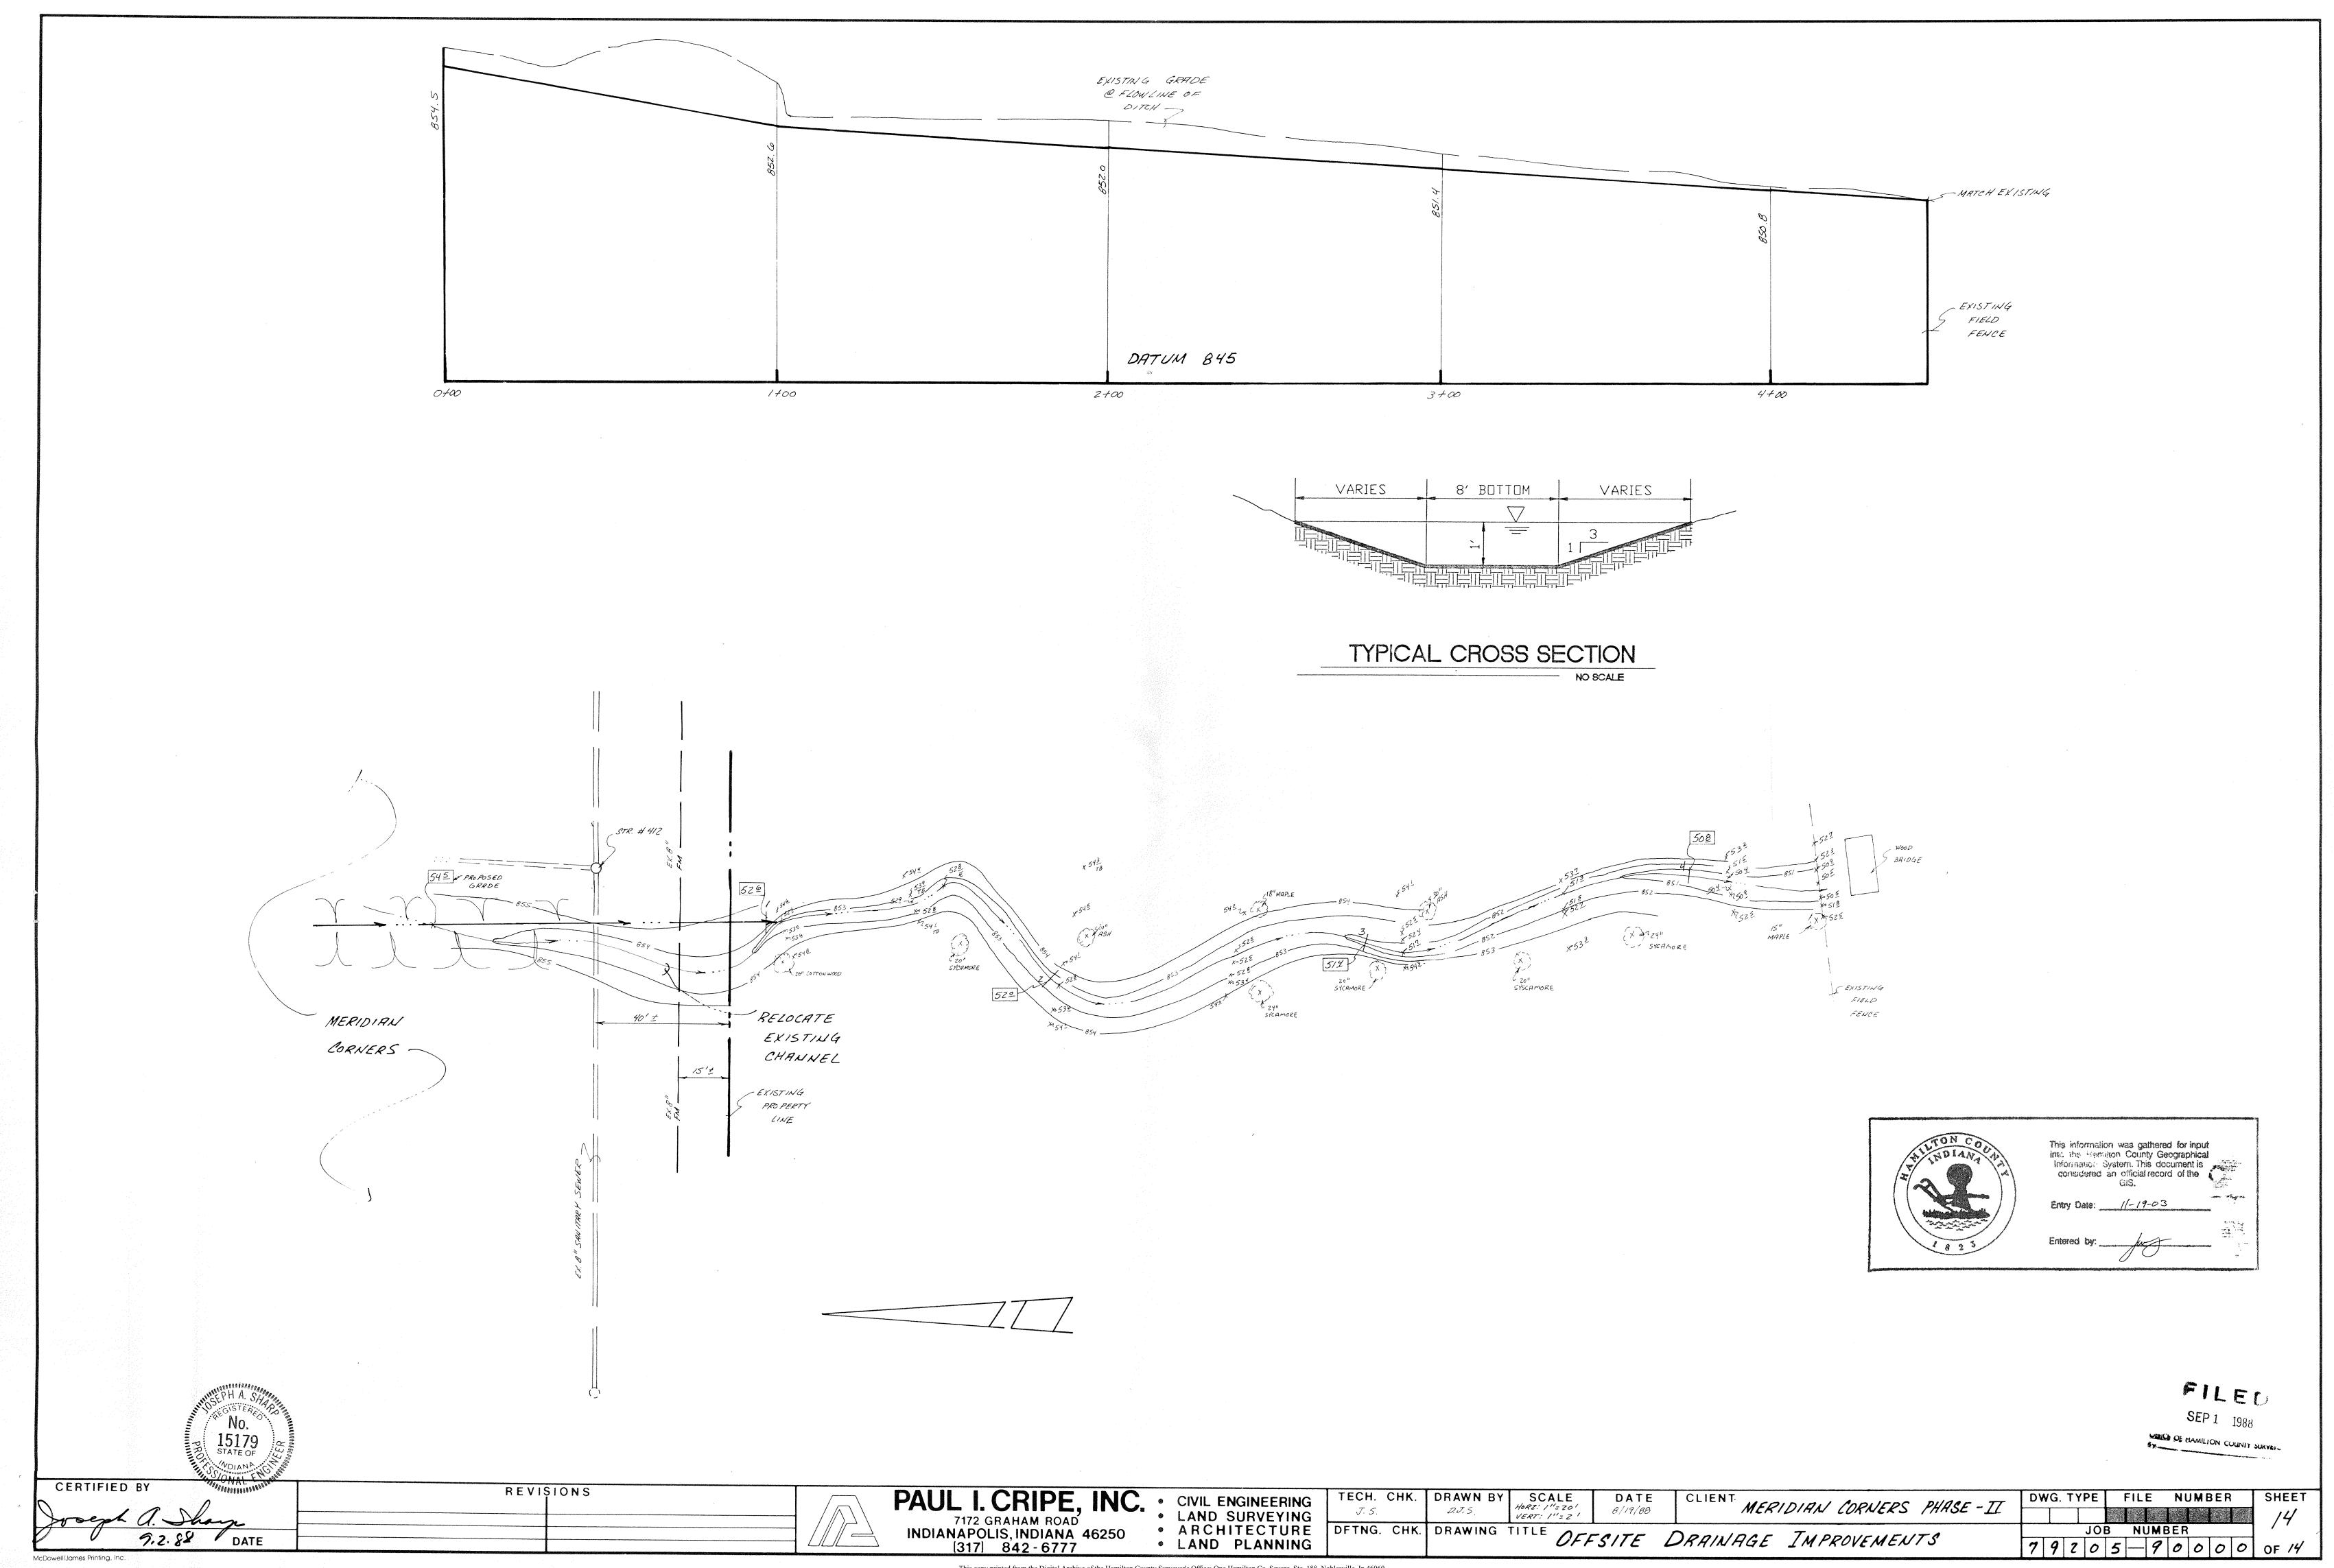
• CIVIL ENGINEERING LAND SURVEYING • ARCHITECTURE LAND PLANNING

TECH. CHK. DRAWN BY DFTNG. CHK. DRAWING TITLE

SCALE NONE SPECIFICATIONS

DATE MERIDIAN CORNERS - PHASE - 2 8/19/88

SHEET DWG. TYPE | FILE NUMBER JOB NUMBER 7 9 2 0 5 - 9 0 0 0 0







Kenton C. Ward, CFM Surveyor of Hamilton County Phone (317) 776-8495 Tax (317) 776-9628

Suite 188 One Hamilton County Square Noblesville, Indiana 46060-2230

Map Correction-Field Verification

Drain Number: 86

Drain Length: 49 45

Drain Name: JRCollins #1: Meridian Corners Change +/-: -259
Prose 1 ? Hamilton

xing Phuse II

Date: 5-28-2010

New Length: 4686


Verified By: SLM

City of carmer/ACE praint 05-01

Notes & Sketch: See attached Map.

Pipe & Structures were removed with the Illinois Street Improvements done by the City of Carmel. Drain was removed between the following Structures: 717-716, 716-737 End Pipe -717, 714-713, 713-736. STRucture 737 was replaced by structure 201 : 8' of 18"
RCP was added. Also it should be noted that's there is a correction of footage in this report as well.

Suzanne L. Mills **GIS Specialist**

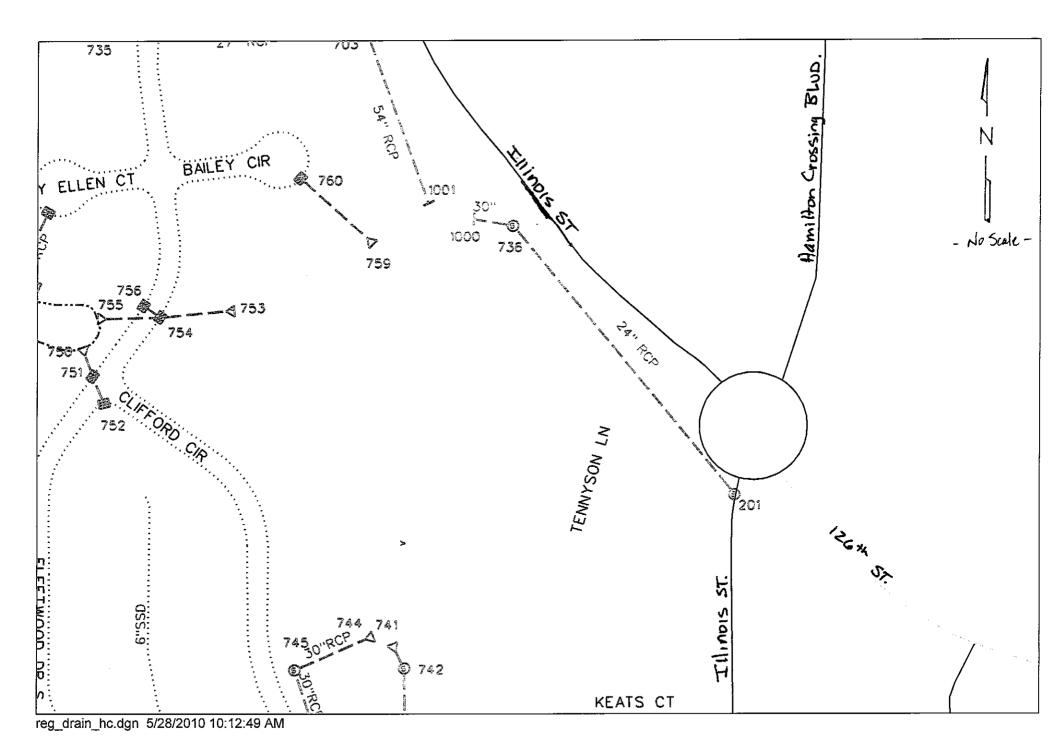

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